

REVISED PER CITY COMMENTS MAY 24, 2019 4 REVISED PER SYSCO COMMENTS MAY 17, 2019 3 REVISED PER CITY COMMENTS MAR. 4, 2019 REVISED PER CITY COMMENTS JAN. 10, 2019 SEPT. 10, 2018 ISSUED FOR SITE PLAN CONTROI Date theck and verify all dimensions Do not scale drawing pefore proceeding with the work SCALE 1:750

**NOT FOR CONSTRUCTION** 

-PROPOSED SITE

SILT FENCE

LOCATION

STRAW BALE CHECK DAM

(AS PER OPSD 219.180)

ROOF DRAIN LOCATION

ROOF SCUPPER LOCATION

WATER COVER TABLE POIN

CROSSING CONFLICT TABLE

OVERHEAD DOOR ENTRANC

PROPOSED ENTRANCE

(AS PER OPSD 219.130)

LOCATION PLAN

BARRIER CURB

MOUNTABLE CURB

**HEAVY DUTY ASPHALT** 

CONCRETE SIDEWALK

PAVING STONE

STORM MANHOLE

CB6 DI6 CATCHBASIN OR DITCH INLET

PERFORATED PIPE IN SWALES

FIRE HYDRANT

WATER VAVLE/CHAMBER

WATER METER LOCATION

REMOTE METER LOCATION

CENTRELINE OF SWALE

SLOPING AT 3:1

(UNLESS SPECIFIED)

PROPOSED ELEVATION

TOP OF WALL ELEVATION BOTTOM OF WALL ELEVATION

EMERGENCY OVERLAND

EXISTING ELEVATION

SWALE ELEVATION

FLOW ROUTE

— · · · · · · · · CENTRELINE OF DITCH

<sup>ECB4</sup>⊜**===** LANDSCAPE CATCHBASIN

SANITARY MANHOLE

CURB DEPRESION


- EASEMENT

EGEND

McINTOSH PERRY

# 115 Walgreen Road, RR3, Carp, ON KOA 1L0

Tel: 613-836-2184 Fax: 613-836-3742 www.mcintoshperry.com

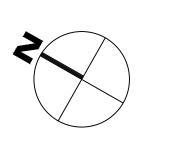

BBS CONSTRUCTION LTD. 1805 WOODWARD DRIVE

OTTAWA, ON K2C 0P9

SYSCO TANNIS - FACILITY EXPANSION 2390 STEVENAGE DRIVE

OTTAWA, ON K1G 3W3

Drawing Title:

SITE SERVICING PLAN

Scale:	1:750	Project Number:
Drawn By:	P.G.K.	CP-18-0170
Checked By:	R.P.K.	Drawing Number:
Designed By:	P.G.K.	C102

12. DYE TESTING IS TO BE COMPLETED ON SANITARY SERVICE TO CONFIRM PROPER CONNECTION TO THE SANITARY SEWER MAIN. 13. ALL CATCHBASIN AND CATHCBASIN MANHOLE LEADS ARE TO BE MINIMUM 200mmØ WITH

MINIMUM 1.0% SLOPE UNLESS OTHERWISE NOTED 14. ALL CATCHBASINS EXCLUDING LANDSCAPE CATCHBASINS ARE TO HAVE 150 mm Ø PERFORATED PIPE FOR 3.0m ON ALL AVAILABLE SIDES AS PER CITY OF OTTAWA STANDARD

15. FOUNDATION BACKWATER VALVES AND SANITARY BACKWATER VALVES ARE TO BE INSTALLED AS PER CITY OF OTTAWA STANDARD DRAWINGS \$14, \$14.1 & \$14.2.

#### WATERMAIN NOTES

CONSTRUCT ALL WATERMAINS AND APPURTENANCES IN ACCORDANCE WITH OPSD STANDARDS AND SPECIFICATIONS, AS WELL AS CITY OR TOWNSHIP STANDARDS.

INDUSTRIAL/COMMERCIAL SERVICE CONNECTIONS TO BE 50mm COPPER PIPING AND SHALL CONFORM TO ASTM B88 TYPE 'K' SOFT.

WATERMAINS AND/OR WATER SERVICES ARE TO HAVE A MINIMUM COVER OF 2.4m. OTHERWISE THERMAL INSULATION IS REQUIRED AS PER CITY OR TOWNSHIP STANDARDS (IF

IF THE WATERMAIN MUST BE DEFLECTED TO MEET ALIGNMENT, ENSURE THAT THE AMOUNT OF DEFLECTION USED IS EQUAL TO OR LESS THAN THAT WHICH IS RECOMMENDED BY THE

USE APPROVED SADDLE CONNECTION WITH MAIN (CORPORATION) STOP AS PER CITY OF

OTTAWA STANDARD DRAWING 'W26'. CONNECTION TO EXISTING BY CITY OR TOWNSHIP FORCES. EXCAVATION, BACKFILLING AND REINSTATEMENT IS TO BE COMPLETED BY THE CONTRACTOR.

THERMAL INSULATION OF WATERMAINS AT OPEN STRUCTURES AS PER CITY OR TOWNSHIP STANDARDS (IF AVAILABLE) OR OPSD 1109.030.

THERMAL INSULATION OF WATERMAINS UNDER ROAD SIDE DITCHES AS PER CITY OF OTTAWA

INV 80.30 ALL STORM AND SANITARY
EWERS ARE TO HAVE
ACKWATER VALVES INSTAL PER CITY STANDARDS S14, XISTING SERVICES ARE TO BE THE PROPERTY LINE TO THE ATISFACTION OF CITY SEWEI PROPOSED BUILDING 1-STOREY 12,160m<sup>2</sup> F.FL. 83.00 U.S.F. 81.40 22 ROOF DRAINS HEAD 0.095m \_\_\_\_\_CB10 T/G 82.95 24.80m - 375mmØ INV 81.00

S14.1 OR S14.2 OPERATIONS ALL ENTRANCES ARE TO BE CONSTRUCTED AS PER CITY STANDARD DETAIL SC7.1

STANDARD DRAWING 'W21'

0.31 300mmØ WATERMAIN TOP 80.34 525mmØ STM SEWER INV 80.98

250mmØ SAN SEWER OBV 80.68 525mmØ STM SEWER INV 80.98 300mmØ WATERMAIN TOP 79.71

L50mmØ HYDRANT LEAD TOP 79.75 525mmØ STM SEWER INV 80.99

VERTICAL BENDS REQUIRED, MINIMUM SEPARATION AS PER CITY STANDARD DETAILS W25 & W25.2

**CROSSING CONFLICT TABLE** 

**SEPARATION** 

0.60

0.50\*

0.25\*

1.36

0.74

0.23

0.50\*

0.97

0.59

0.88

1.35

0.25

1.07

1.11

0.76

0.50\*

DESCRIPTION

675mmØ STM SEWER INV 79.89

300mmØ SAN SEWER OBV 79.27 675mmØ STM SEWER INV 79.88

300mmØ WATERMAIN TOP 79.38 300mmØ WATERMAIN BOT 79.69

200mmØ SAN SEWER OBV 79.44 525mmØ STM SEWER INV 80.94

200mmØ SAN SEWER OBV 79.58 525mmØ STM SEWER INV 80.94

300mmØ WATERMAIN TOP 80.20 525mmØ STM SEWER INV 80.91

250mmØ STM SEWER OBV 80.6 250mmØ STM SEWER INV 80.5

300mmØ WATERMAIN TOP 80.0

250mmØ STM SEWER INV 80.62

200mmØ SAN SEWER OBV 79.65 300mmØ STM SEWER INV 81.08

300mmØ WATERMAIN TOP 80.20 300mmØ STM SEWER INV 81.09


200mmØ SAN SEWER OBV 79.74 675mmØ STM SEWER INV 80.70

250mmØ STM SEWER OBV 80.45 250mmØ STM SEWER INV 80.28

300mmØ WATERMAIN TOP 79.21 525mmØ STM SEWER INV 80.64

50mmØ HYDRANT LEAD TOP 79.5 300mmØ WATERMAIN BOT 80.48

0.64 0.67 1.11 1.18

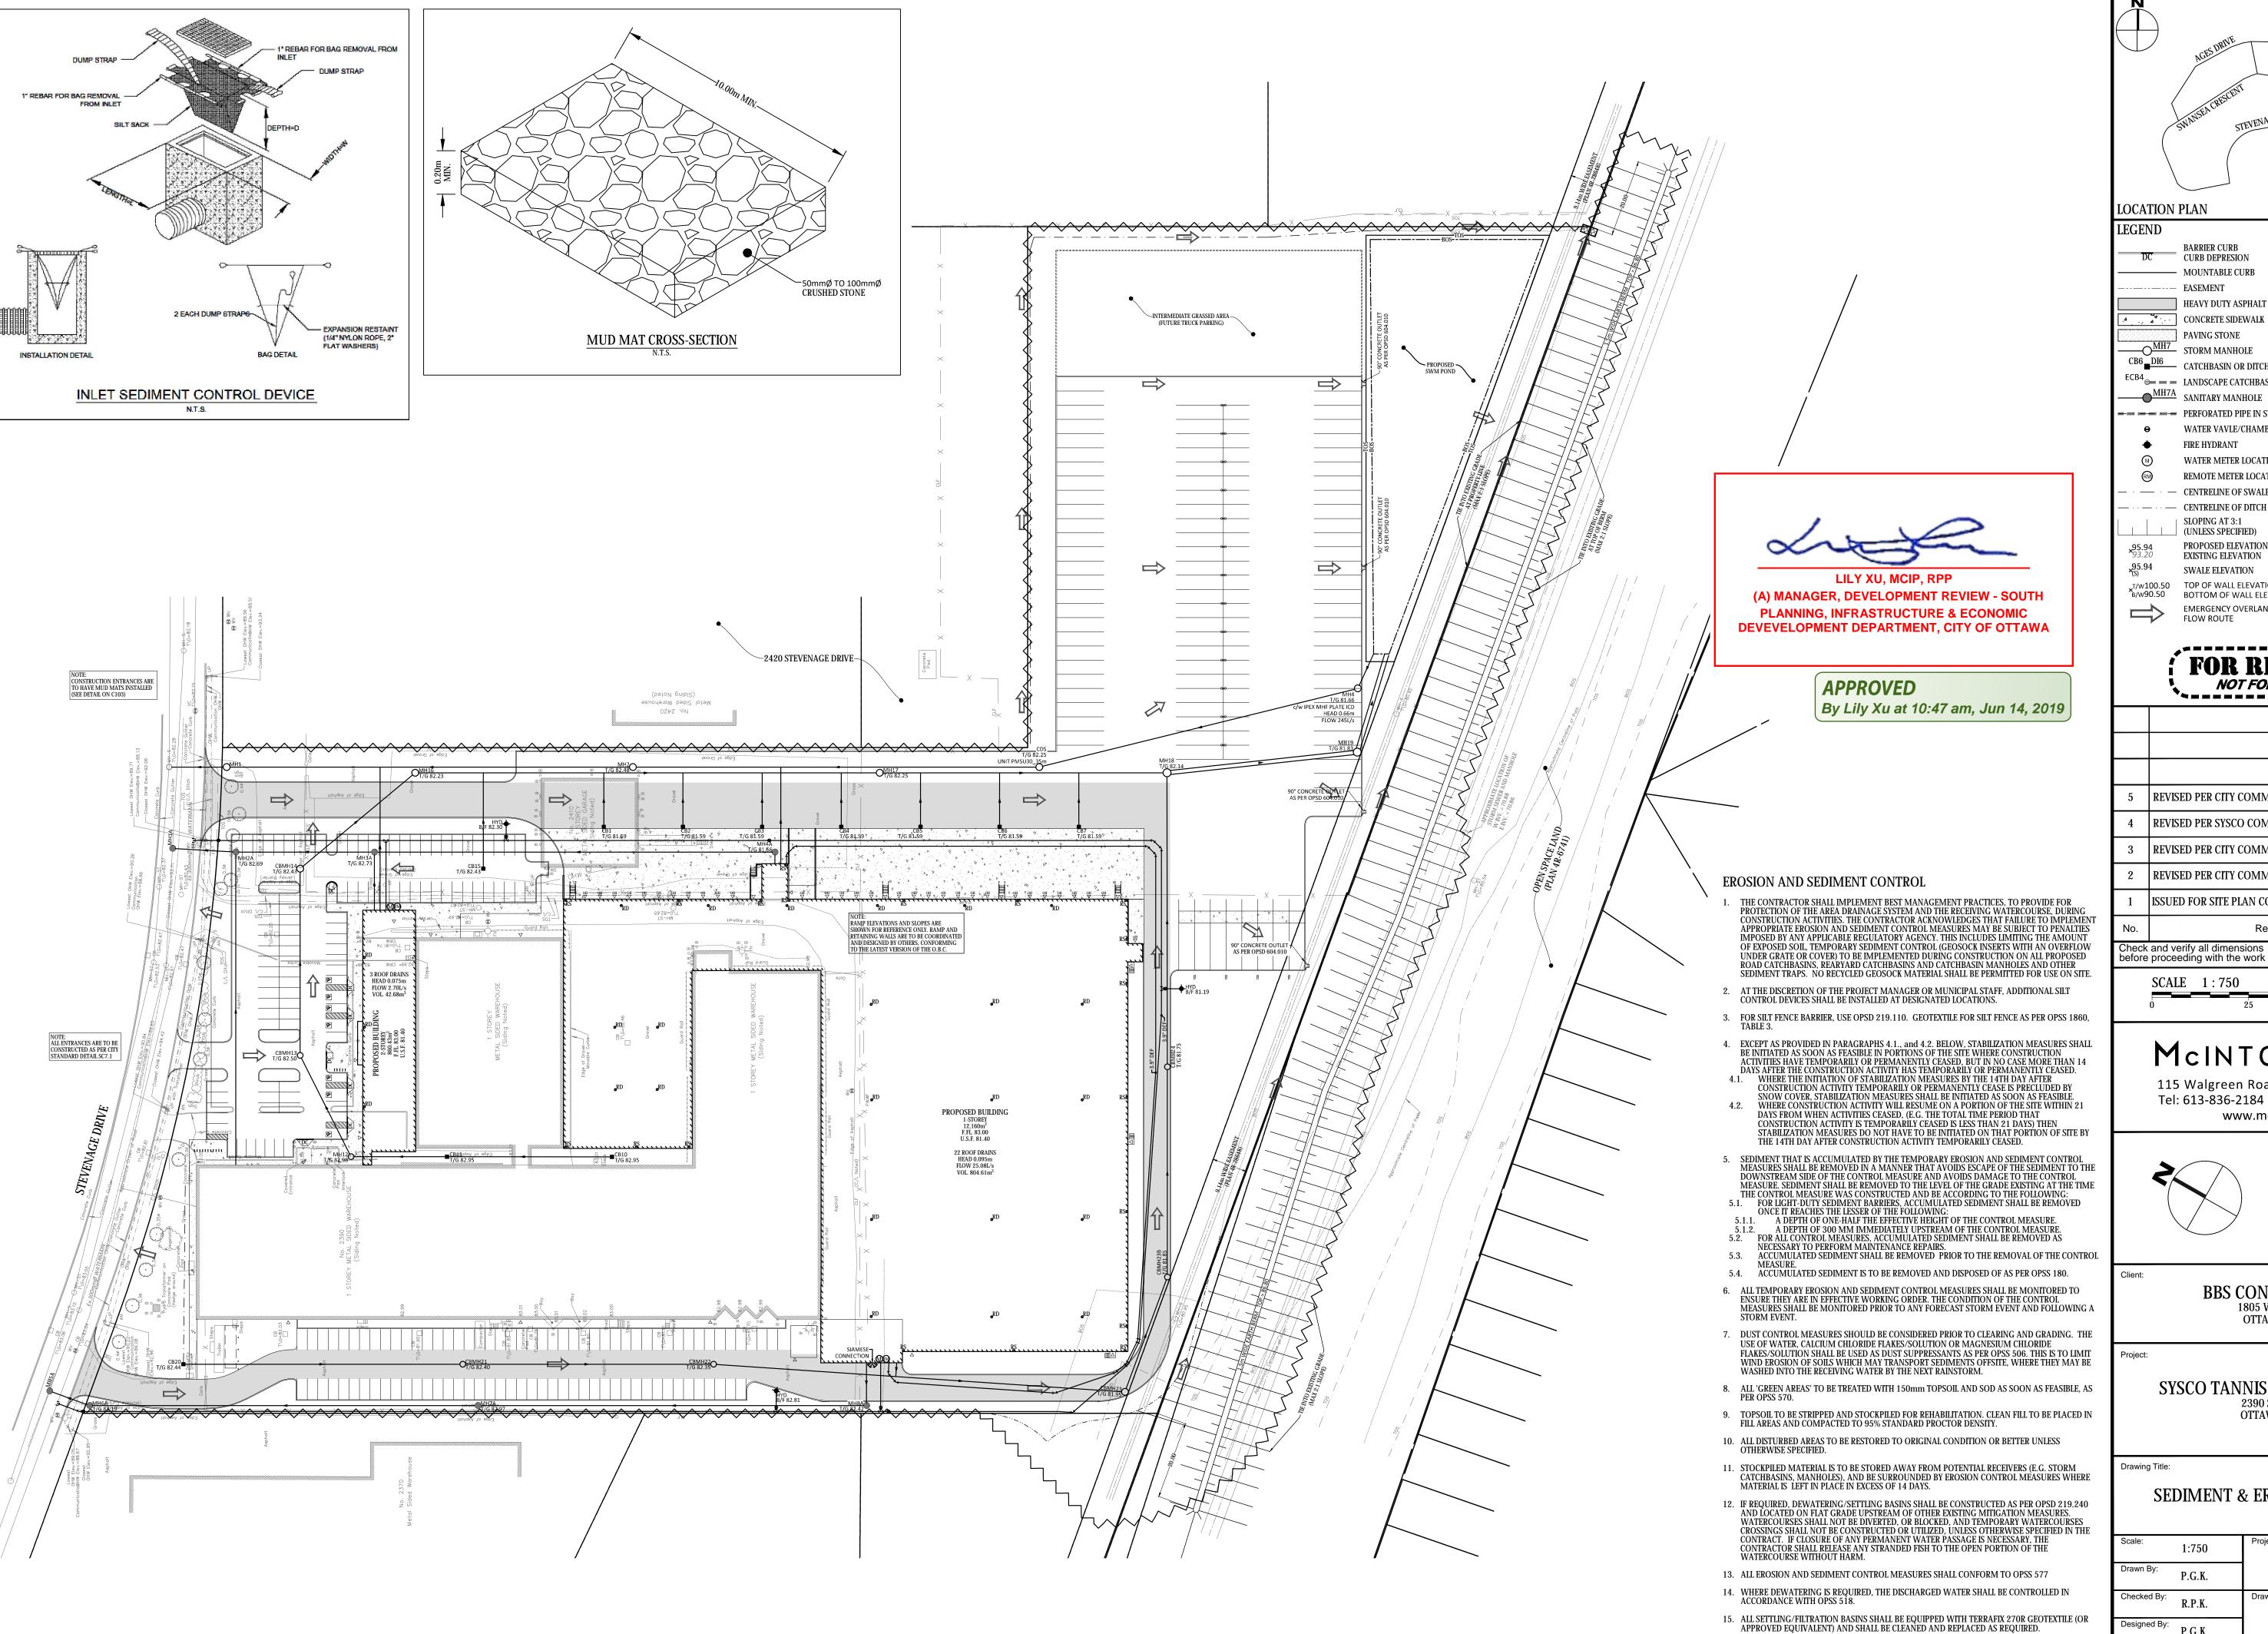

└PROPOSED SITE

SILT FENCE
(AS PER OPSD 219.130)

STRAW BALE CHECK DAM

(AS PER OPSD 219.180)

ROOF DRAIN LOCATION

ROOF SCUPPER LOCATION

WATER COVER TABLE POIN

CROSSING CONFLICT TABLE

PROPOSED ENTRANCE

OVERHEAD DOOR ENTRANC

#### BARRIER CURB CURB DEPRESION — MOUNTABLE CURB **EASEMENT** HEAVY DUTY ASPHALT CONCRETE SIDEWALK PAVING STONE

————— STORM MANHOLE CB6 DI6 CATCHBASIN OR DITCH INLET ECB4 LANDSCAPE CATCHBASIN MH7A SANITARY MANHOLE

PERFORATED PIPE IN SWALES WATER VAVLE/CHAMBER FIRE HYDRANT WATER METER LOCATION

REMOTE METER LOCATION · — · — CENTRELINE OF SWALE - · · · — CENTRELINE OF DITCH SLOPING AT 3:1 (UNLESS SPECIFIED) PROPOSED ELEVATION

SWALE ELEVATION TOP OF WALL ELEVATION BOTTOM OF WALL ELEVATION EMERGENCY OVERLAND FLOW ROUTE


### NOT FOR CONSTRUCTION

	5	REVISED PER CITY COMMENTS	MAY 24, 2019
	4	REVISED PER SYSCO COMMENTS	MAY 17, 2019
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	2	REVISED PER CITY COMMENTS	JAN. 10, 2019
	1	ISSUED FOR SITE PLAN CONTROL	SEPT. 10, 2018
NT S	No.	Revisions	Date
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SCALE 1:750

## McINTOSH PERRY 115 Walgreen Road, RR3, Carp, ON KOA 1L0

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Do not scale drawings

BBS CONSTRUCTION LTD. 1805 WOODWARD DRIVE OTTAWA, ON K2C 0P9

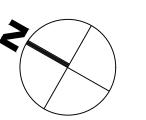SYSCO TANNIS - FACILITY EXPANSION 2390 STEVENAGE DRIVE OTTAWA, ON K1G 3W3

SEDIMENT & EROSION CONTROL PLAN

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Scale:	1:750	Project Number:	)-8
Drawn By:	P.G.K.	CP-18-0170	2-18
Checked By:	R.P.K.	Drawing Number:	7-1
Designed By:	P.G.K.	C103	<u>D</u> 0,
		#17811	

