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TECHNICAL MEMORANDUM

DATE: 2019-03-11

TO: Richard Buchanan, CET Program Manager, Development Review

SUBJECT: Zibi Ontario - Windmill Developments Group Ltd. – Zibi Ontario Phase 2 (Block 207)

- OUR FILE: DSEL Project No.14-717
- ATTACHMENTS: MSS Water Demand Calculation Sheet, prepared by DSEL dated May 2018
 - Phase 2 Water Demand Calculation Sheet, prepared by DSEL dated March 2019
 - Phase 2 Wastewater Discharge Calculation Sheet, prepared by DSEL – dated March 2019
 - Phase 2 Stormwater Management Plan, prepared by DSEL dated March 2019
 - Phase 2 Storm Sewer Design Sheet, prepared by DSEL dated March 2019
 - Zibi Master Plan, prepared by Fotenn Planning + Design dated December 2016
 - Zibi Block 207 Site Plan, prepared by Kohn Partnership Architects – dated March 6, 2019

Windmill Developments has retained DSEL to prepare an amendment to the Functional Servicing and Stormwater Management Report in support of their Site Plan Control (SPC) application for Phase 2 of the Zibi Ontario lands. Phase 2 will include the construction of Block 207 in accordance with the Master Servicing Plan prepared by DSEL dated June 2018 (**MSS**), refer to the Master Plan drawing in the **Attachments**. The proposed Block 207 development involves the construction of a 6-storey building consisting of 5,028m² of office space, 644m² of retail space, and a restaurant with estimated seating for 300 people.

This document is an addendum to the previously approved Functional Servicing and Stormwater Management Report – Phase 1 prepared by DSEL dated August 2018 (*Approved FSR*). Phase 1 included Blocks 205A &208 with a mix of residential, office and retail space. Phase 2 is proposed to be serviced through infrastructure designed in Phase 1. Phase 1 infrastructure is proposed to be constructed in Spring and Summer 2019, prior to construction of Phase 2.

EMAIL

Water servicing for Block 207 will be accomplished by a dual 150mm watermain connection to the 200mm private watermain within Perley Street which will be constructed as part of the Phase 1 works. The dual connection is required in accordance with City of Ottawa technical bulletin ISDTB-2014-02, due to an anticipated daily average flow of greater than 50 m³/day.

Table 1

Water Demand – MSS and Proposed Phase 1 & 2									
Design Parameter	MSS Demand (Block 205A, 207, 208) (L/min)	Anticipated Demand ¹ Phase 1 (L/min)	Anticipated Demand ¹ Phase 1 & 2 (L/min)	Boundary Condition ² (m H ₂ O / kPa) Connection @ Booth Street					
Average Daily									
Demand	69.0	32.8	88.1	61.7	605.3				
Max Day + Fire Flow	126.9 + 10,000 =	128.7 + 16,000 =	221.7 + 13,000 =						
-	10,126.0	16,128.7	13,221.7	50.3	493.4				
Peak Hour	251.9	198.5	347.8	54.7	536.6				
 Water demand calculation Boundary conditions supp Booth Street 53.4m 					levation @				

The combined Phase 1 and Phase 2 water demand has increased by **28%** from demands contemplated in the **MSS** for **Blocks 205A**, **207**, **208**, refer to **Attachments** for water demand calculations. A hydraulic water distribution model was prepared for the MSS. The estimate pressures at Block 207 were anticipated to be between **600.5** kPa and **526.5** kPa during average day and peak hour scenarios, respectively. Pressures are anticipated to continue to be above the desired pressure per the **Water Supply Guidelines** with the increase in demand. As such, pressure reducing valves may be required.

Fire demands for Block 207 was calculated using the *City of Ottawa Technical Bulletin ISTB-2018-02*, resulting in a fire flow of **13,000 L/min**, less than contemplated in the **Approved FSR**.

Sanitary Servicing

Block 207 is proposed to be serviced by a connection to the 250mm sanitary sewer within Perley Street which will be constructed in Phase 1. The Phase 1 sanitary sewers were sized to convey the flow from Block 207 in accordance with the *Approved FSR*.

As indicated in the *Approved FSR*, it is proposed to construct a temporary pumping station within the footprint of the existing Building 535 as shown on drawing *SSP-1* to service the first phases of development. Sanitary flows from Phase 2 are directed to the temporary pumping station which will convey flows through twin 200mm forcemains that run south down Booth Street. The pumping station design report prepared by Hatch, dated November 2018, indicates that the temporary pumping station is designed to pump a peak wet weather flow of *13 L/s*. Refer to the *Approved FSR* for further detail on the interim pump station.

Table 2 below summarizes the anticipated wastewater discharge from the proposed Phase 1 and 2 development.

Design Parameter	MSS Flow (L/s)	Phase 1 Flow (L/s)	Phase 1 & 2 Flow (L/s)
Average Dry Weather Flow Rate	22.6	0.7	5.5
Peak Dry Weather Flow Rate	51.7	1.8	9.1
Peak Wet Weather Flow Rate	53.6	2.2	9.5

Table 2 Summary of Anticipated Wastewater Discharge

As shown in **Table 2** above, Phase 2 results in an increase in sanitary discharge, however, the temporary pumping station has sufficient capacity to convey the proposed sanitary flows from Phase 2 development and results in less flow than contemplated in the **MSS**.

It is recommended that the flow within the pumping station be monitored to confirm the actual available capacity to support future phases of the proposed development.

Stormwater Management

Storm water runoff from proposed Block 207 development will discharge through a service connection to the 450mm storm sewer within Perley Street which ultimately outlets to the north edge of Chaudière Island, east of Booth Street, consistent with the *Approved FSR*.

The proposed building footprint of Block 207 has been updated from the contemplated footprint in the **MSS**. Refer to the **SWM-1** drawing included in the attachments for updated catchment areas directed to the storm sewer. As shown in the revised storm design sheet, the sewers have sufficient capacity to convey the updated flows.

The overall imperviousness is consistent with previous approvals; therefore, the oil/grit separator will continue to function as intended.

Required Permits / Approvals

The proposed development is subject to the site plan control approval process. The City of Ottawa must approve the engineering design drawings and reports prior to the issuance of site plan control.

An amendment to the previously issued Environmental Compliance Approval (ECA #1505-B96UCV) is required to reflect the increase in service area to the interim pump station and offsite sanitary infrastructure. Yours truly, **David Schaeffer Engineering Ltd.**



Per: Adam D. Fobert, P.Eng.

Yours truly, **David Schaeffer Engineering Ltd.**

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Per: Steven L. Merrick, P.Eng.

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Windmill Zibi - Ontario Proposed Conditions (MSS)

Water Demand Design Flows per Unit Count City of Ottawa - Water Distribution Guidelines, July 2010



Phase	Block	Туре	Unit	Rate	No. of Units	Avg Day L/min	Max Day L/min	Peak Hour L/min
1	208	Office	75	L/p/d	287	15.0	22.4	40.4
1	208	Retail		L/m²/d	445	1.5	2.3	4.2
1	205.5A	Res	474.6	L/unit/d	71	23.4	58.5	128.7
1	205.5A	Retail		L/m²/d	1825	6.3	9.5	17.1
1	207	Office	75	L/p/d	385	20.1	30.1	54.2
1	207	Retail		L/m²/d	597	2.1	3.1	5.6
1	206	Res	474.6	L/unit/d	198	65.3	163.1	358.9
1	206	Office		L/p/d	395	20.6	30.8	55.5
1	206	Retail		L/m²/d	612	2.1	3.2	5.7
1	204A	Office	75	L/p/d	1049	54.6	136.6	300.5
1	204A	Retail	5	L/m ² /d	1626	5.6	8.5	15.2
2	211	Office	75	L/p/d	839	43.7	109.3	240.4
2	211	Retail		L/m²/d	1301	4.5	6.8	12.2
L	2	rtotai		L/III / G	1001	1.0	0.0	12.2
3	209	Office	75	L/p/d	965	50.3	75.4	135.7
3	209	Retail		L/m²/d	1496	5.2	13.0	28.6
3	210A&B	Office		L/p/d	495	25.8	38.7	69.6
3	210A&B	Retail		L/m²/d	767	2.7	4.0	7.2
	210/102	rtotai		<u>_</u> /u		2.1	1.0	7.2
4	205B	Res	474.6	L/unit/d	67	22.1	55.2	121.5
4	205B	Office		L/p/d	163	8.5	12.8	23.0
4	205B	Retail	5	L/m²/d	253	0.9	1.3	2.4
4	204B	Res	474.6	L/unit/d	115	37.9	94.8	208.5
4	204B	Retail		L/p/d	264	13.8	20.7	37.2
4	204B	Office	5	L/m²/d	410	1.4	2.1	3.8
5	201	Res	474.6	L/unit/d	170	56.0	140.1	308.2
5	201	Office		L/p/d	182	9.5	14.2	25.5
5	201	Retail	5	L/m²/d	281	1.0	1.5	2.6
5	202	Res		L/unit/d	90	29.7	74.2	163.1
5	202	Office		L/p/d	107	5.6	8.4	15.1
5	202	Retail	5	L/m²/d	166	0.6	0.9	1.6
5	203	Res		L/unit/d	180	59.3	148.3	326.3
5	203	Retail		L/p/d	306	16.0	23.9	43.1
5	203	Retail		L/m²/d	475	1.6	2.5	4.5
6	212	Office	75	l /p/d	1804	94.0	140.9	253.7
				L/p/d L/m ² /d				
6	212	Retail	5	L/m /a	2796	9.7	14.6	26.2
7	213	Res	474.6	L/unit/d	200	65.9	164.8	362.5
7	213	Office		L/p/d	150	7.8	11.7	21.1
7	213	Retail	5	L/m²/d	233	0.8	1.2	2.2
8	214	Office	75	L/p/d	587	30.6	45.9	82.6
8	214	Retail	5	L/m ² /d	910	3.2	4.7	8.5
8	214	Office		L/p/d	587	30.6	4.7	82.6
8	215	Retail		L/m ² /d	910	3.2	7.9	17.4
		0.00	_				-	
EO	1	Office	75	L/p/d	12	0.6	0.9	1.7
					Total	858.9	1754.6	3624.5

Notes:

* Development stats per Windmill schedule dated 2016-02-01 and additional information received via email 2016-02-08.

* Office unit rate per Ontario Building Code 8.2.1.3.B.

* Residential Unit rate assuming 65% one bedroom (1.4p/unit), 30% two bedroom (2.1 p/unit), 5% three bedroom (3.0p/unit)

* Special Event area washrooms only per Windmill email 2016-02-08.

* Energy Ottawa maximum employees to work at Chaudiere Office provided by EO via letter dated March 1, 2016

Estimated Total Residential Population

Max Day PF Peak Hour PF 1844 2.5 5.5

Windmill Zibi - Ontario Phase 1 and 2

Water Demand Design Flows per Unit Count City of Ottawa - Water Distribution Guidelines, July 2010



Phase	Block	Туре	Unit	Rate	No. of Units	Avg Day	Max Day	Peak Hour
						L/min	L/min	L/min
1A	208	Office	75	L/9.3m²/d	975	5.5	8.2	14.8
1A	208	Retail	2.5	L/m²/d	736	1.3	1.9	3.5
1	208	Restaurant	125	L/seat/d	8	0.7	1.0	1.9
1A	205A	Res	474.6	L/unit/d	71	23.4	114.7	173.2
1A	205A	Retail		L/m²/d	754	1.3	2.0	3.5
2	207	Office	75	L/9.3m ² /d	5028	28.2	42.2	76.0
2	207	Retail	2.5	L/m²/d	644	1.1	1.7	3.0
2	207	Restaurant	125	L/seat/d	300	26.0	39.1	70.3
EO	1	Office	75	L/p/d	12	0.6	0.9	1.7
					Total	88.1	211.7	347.8

Notes:

* Development stats per Windmill schedule dated 2016-02-01 and additional information received via email 2016-02-08.

* Office unit rate per Ontario Building Code 8.2.1.3.B. Assuming 1 employee per 9.3m² of floor space.

* Residential Unit rate assuming 65% one bedroom (1.4p/unit), 30% two bedroom (2.1 p/unit), 5% three bedroom (3.0p/unit)

* Number of Residential units estimated as 850gfa / unit per Windmill development stats dated 2016-02-01.

* Windmill estimated maximum number of employees occupying Albert Island

* Energy Ottawa maximum employees to work at Chaudiere Office provided by EO via letter dated March 1, 2016

Max Day PF Peak Hour PF Estimated Total Residential Population 128

4.9

7.4

Fire Flow Estimation per Fire Underwriters Survey

Water Supply For Public Fire Protection - 1999

Fire Flow Required

1. Ba	se Requirement						
	$F = 220C\sqrt{A}$	L/min	Where	F is	the fire flow,	C is the T	Type of construction and $oldsymbol{A}$ is the Total floor area
	Type of Construction:	Non-Combus	tible Con	structi	on		
		C 0.8 A 6453.0	<i>Type c</i> m²				er FUS Part II, Section 1 FUS Part II section 1
	Fire Flow		2 L/min 0 L/min	roun	ded to the ne	arest 1,00	00 L/min
Adjustments	6						
2. Re	duction for Occupancy Type						
	Combustible	09	%				
	Fire Flow	14000.	0 L/min	-			
3. Re	duction for Sprinkler Protection						
	Sprinklered - Supervised	-50%	%				
	Reduction	-700	0 L/min	-			
N	rease for Separation Distance Cons. of Exposed Wall Non-Combustible Non-Combustible	S.D 20.1m-30m 10.1m-20m	Lw 27 25		LH 0 0	EC 0 0	8% 12%
E	Non-Combustible Non-Combustible	20.1m-20m 20.1m-30m 3.1m-10m % Increase	53 50	3	0 0 0	0 0 0	8% 17% 45% value not to exceed 75%
	Increase	6300.	0 L/min	-			
	Lw = Length of the Exposed Wall Ha = number of storeys of the adjac LH = Length-height factor of expose EC = Exposure Charge		ded up.				
Total Fire Fl	ow						

Fire Flow

13300.0 L/min fire flow not to exceed 45,000 L/min nor be less than 2,000 L/min per FUS Section -13000.0 L/min rounded to the nearest 1,000 L/min

Notes:

-Type of construction, Occupancy Type and Sprinkler Protection information provided by ____ . -Calculations based on Fire Underwriters Survey - Part II

Wastewater Design Flows per Unit Count City of Ottawa Sewer Design Guidelines, 2012



Peak Flow 0.4

Extraneous Flow Allowances

Site Area 1.234 ha

Phase	Block	Туре	Unit	Rate	No. of Units	-	Peaking Factor	
						(L/s)	(-)	(L/s)
1	208	Office	75	L/p/d	105	0.1	1.5	0.1
1	208	Retail	5	L/m²/d	736	0.1	1.5	0.1
1	205A	Res	474.6	L/unit/d	71	0.4	3.6	1.4
1	205A	Retail	5	L/m²/d	754	0.1	1.5	0.1
2	207	Office	75	L/p/d	5028	4.4	1.5	6.5
2	207	Retail	5	L/m²/d	644	0.1	1.5	0.1
2	207	Restaurant	125	L/seat/d	300	0.4	1.5	0.7
1	EX1	Office	75	L/p/d	12	0.01	1.50	0.02
					Total	5.5		9.1
			Total W	letweather	Flow Estimate			9.5

Notes:

* Development stats per Windmill schedule dated 2016-02-01 and additional information received via email 2016-02-08.

* Office unit rate per Ontario Building Code 8.2.1.3.B. assuming 9.3m²/p


* Residential Unit rate assuming 70% one bedroom (1.4p/unit), 30% two bedroom (2.1 p/unit)

* Number of residential units from Site Plan by Hobin Architecture dated May 29,2018

* Retail unit rate per City of Ottawa sewer design guidelines and assumes a 12 hour commercial operation

* Special Event area washrooms only per Windmill email 2016-02-08.


P.F. Estimated Total Residential Population 128 3.6

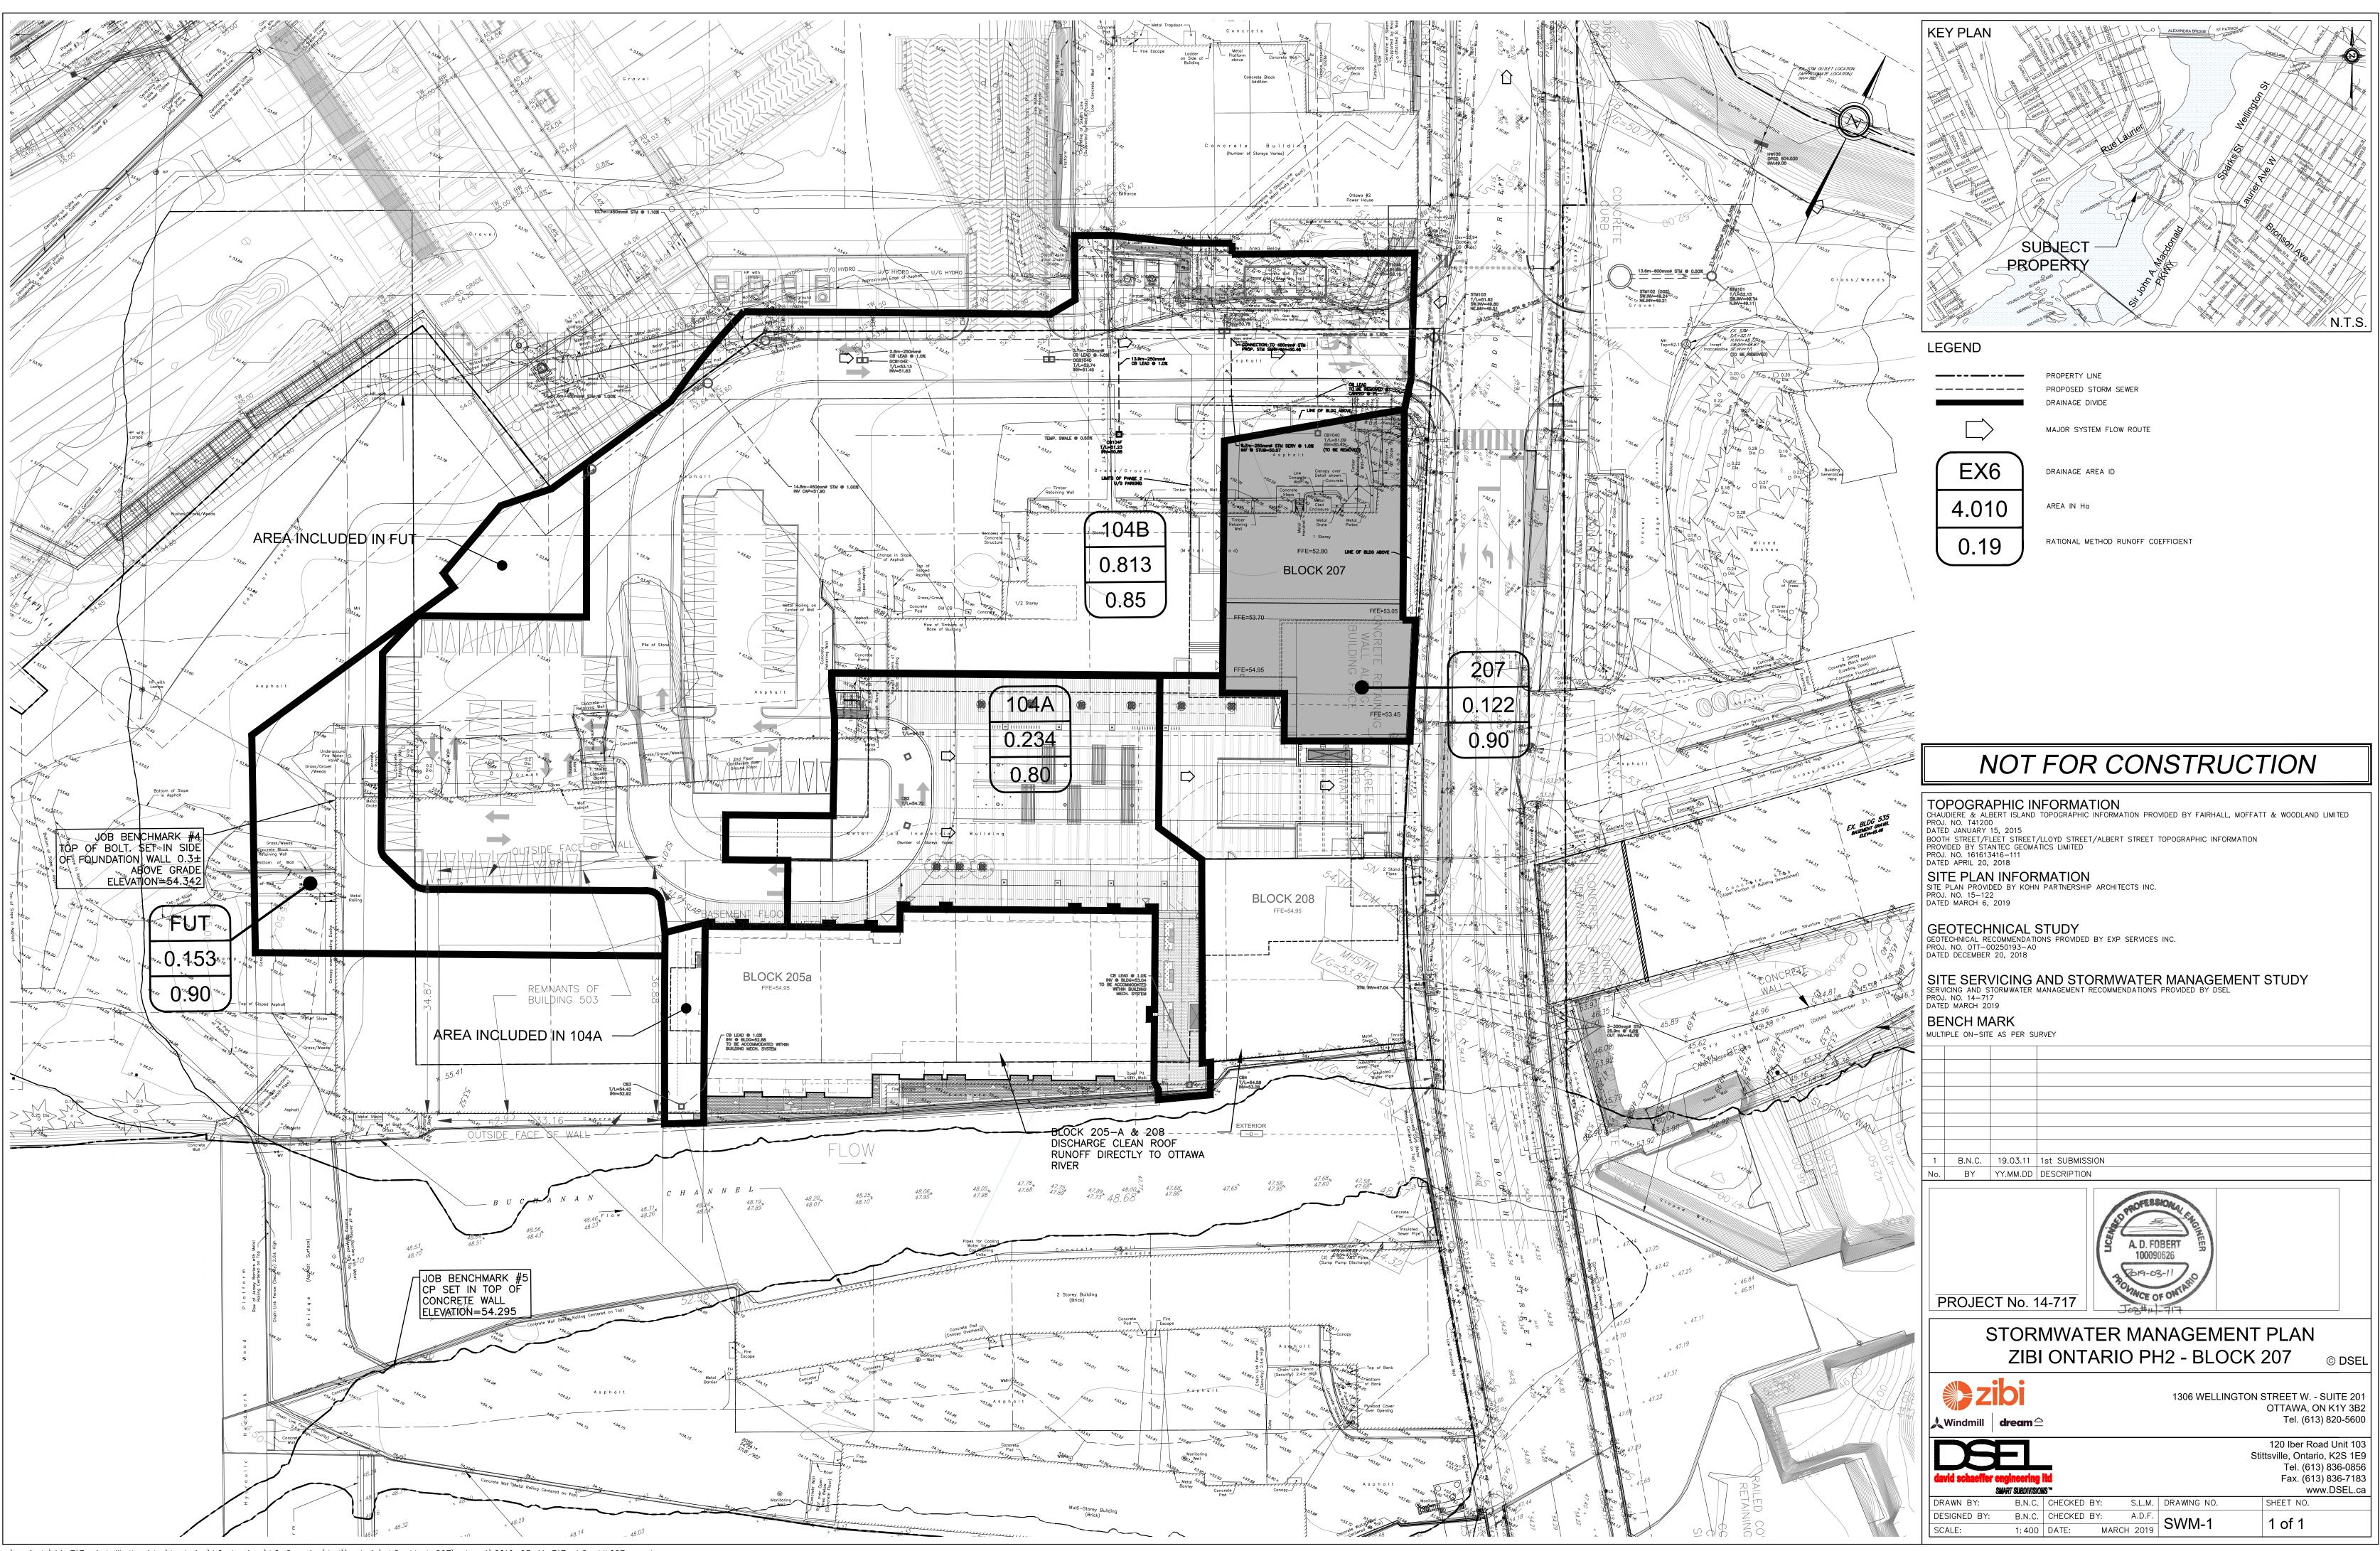


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														Sewer Data	l			
Area ID	Up	Down	Area	С	Indiv AxC	Acc AxC	Тc	I	Q	DIA	Slope	Length	A _{hydraulic}	R	Velocity	Qcap	Time Flow	Q / Q full
			(ha)	(-)			(min)	(mm/hr)	(L/s)	(mm)	(%)	(m)	(m²)	(m)	(m/s)	(L/s)	(min)	(-)
FUT	STM106	STM105	0.153	0.90	0.14	0.14	10.0	104.2	39.9	450	1.00	21.6	0.159	0.113	1.79	285.1	0.2	0.14
	STM105	STM104	0.000	0.85	0.00	0.14	10.2	103.1	39.5	450	1.10	10.7	0.159	0.113	1.88	299.0	0.1	0.13
104B, 207	STM104	STM103	0.935	0.86	0.80	0.94	10.3	102.7	267.6	450	1.50	99.6	0.159	0.113	2.20	349.2	0.8	0.77
	STM103	STM102	0.000	0.00	0.00	0.94	11.1	98.9	258.0	525	0.95	29.1	0.216	0.131	1.94	419.2	0.3	0.62
	STM102	STM101	0.000	0.00	0.00	0.94	11.3	97.8	254.9	600	0.50	13.6	0.283	0.150	1.54	434.2	0.1	0.59
	STM101	HW100	0.000	0.00	0.00	0.94	11.4	97.1	253.2	600	0.50	21.3	0.283	0.150	1.54	434.2	0.2	0.58



Block	Phase	Block Area (acres)	Block GFA (ft ²)	Number of Units	Average Unit Size (ft ²)
ck 1	6	0.49	148,000	145	801
ck 2-3	1	0.78	46,929	0	0
ck 4	6	0.84	101,000	101	881
/GSC	1		78,975	0	0
ck 5	2	0.20	11,000	0	0
ck 6	2	0.18	7,300	0	0
ck 7	3	1.06	116,000	100	792
ck 8	1	0.73	135,000	135	889
ck 9	2	0.11	15,000	15	900
ck 10	2	0.33	104,000	104	1,000
ck 11	1	0.74	74,645	82	779
ck 12	1	0.26	15,000	15	1,000
ck 13	1	0.74	73,698	70	810
ck 14	4	0.56	143,700	0	0
ck 15	4	0.64	108,800	128	813
ck 16	5	0.36	68,000	0	0
ck 17	5	0.60	171,000	0	0
ck 18	5	0.59	208,000	230	814
ck 19	4	0.30	69,800	75	816
ck 20	4	0.65	71,300	79	792
ck 21	5	0.25	59,000	73	727
ck 22	5	0.54	56,000	69	730
ck 23	5	0.41	113,000	140	726
ck 24	2	0.85	115,000	0	0
ck 25	2	0.81	87,538	0	0
ck 26	6	1.39	58,000	65	803

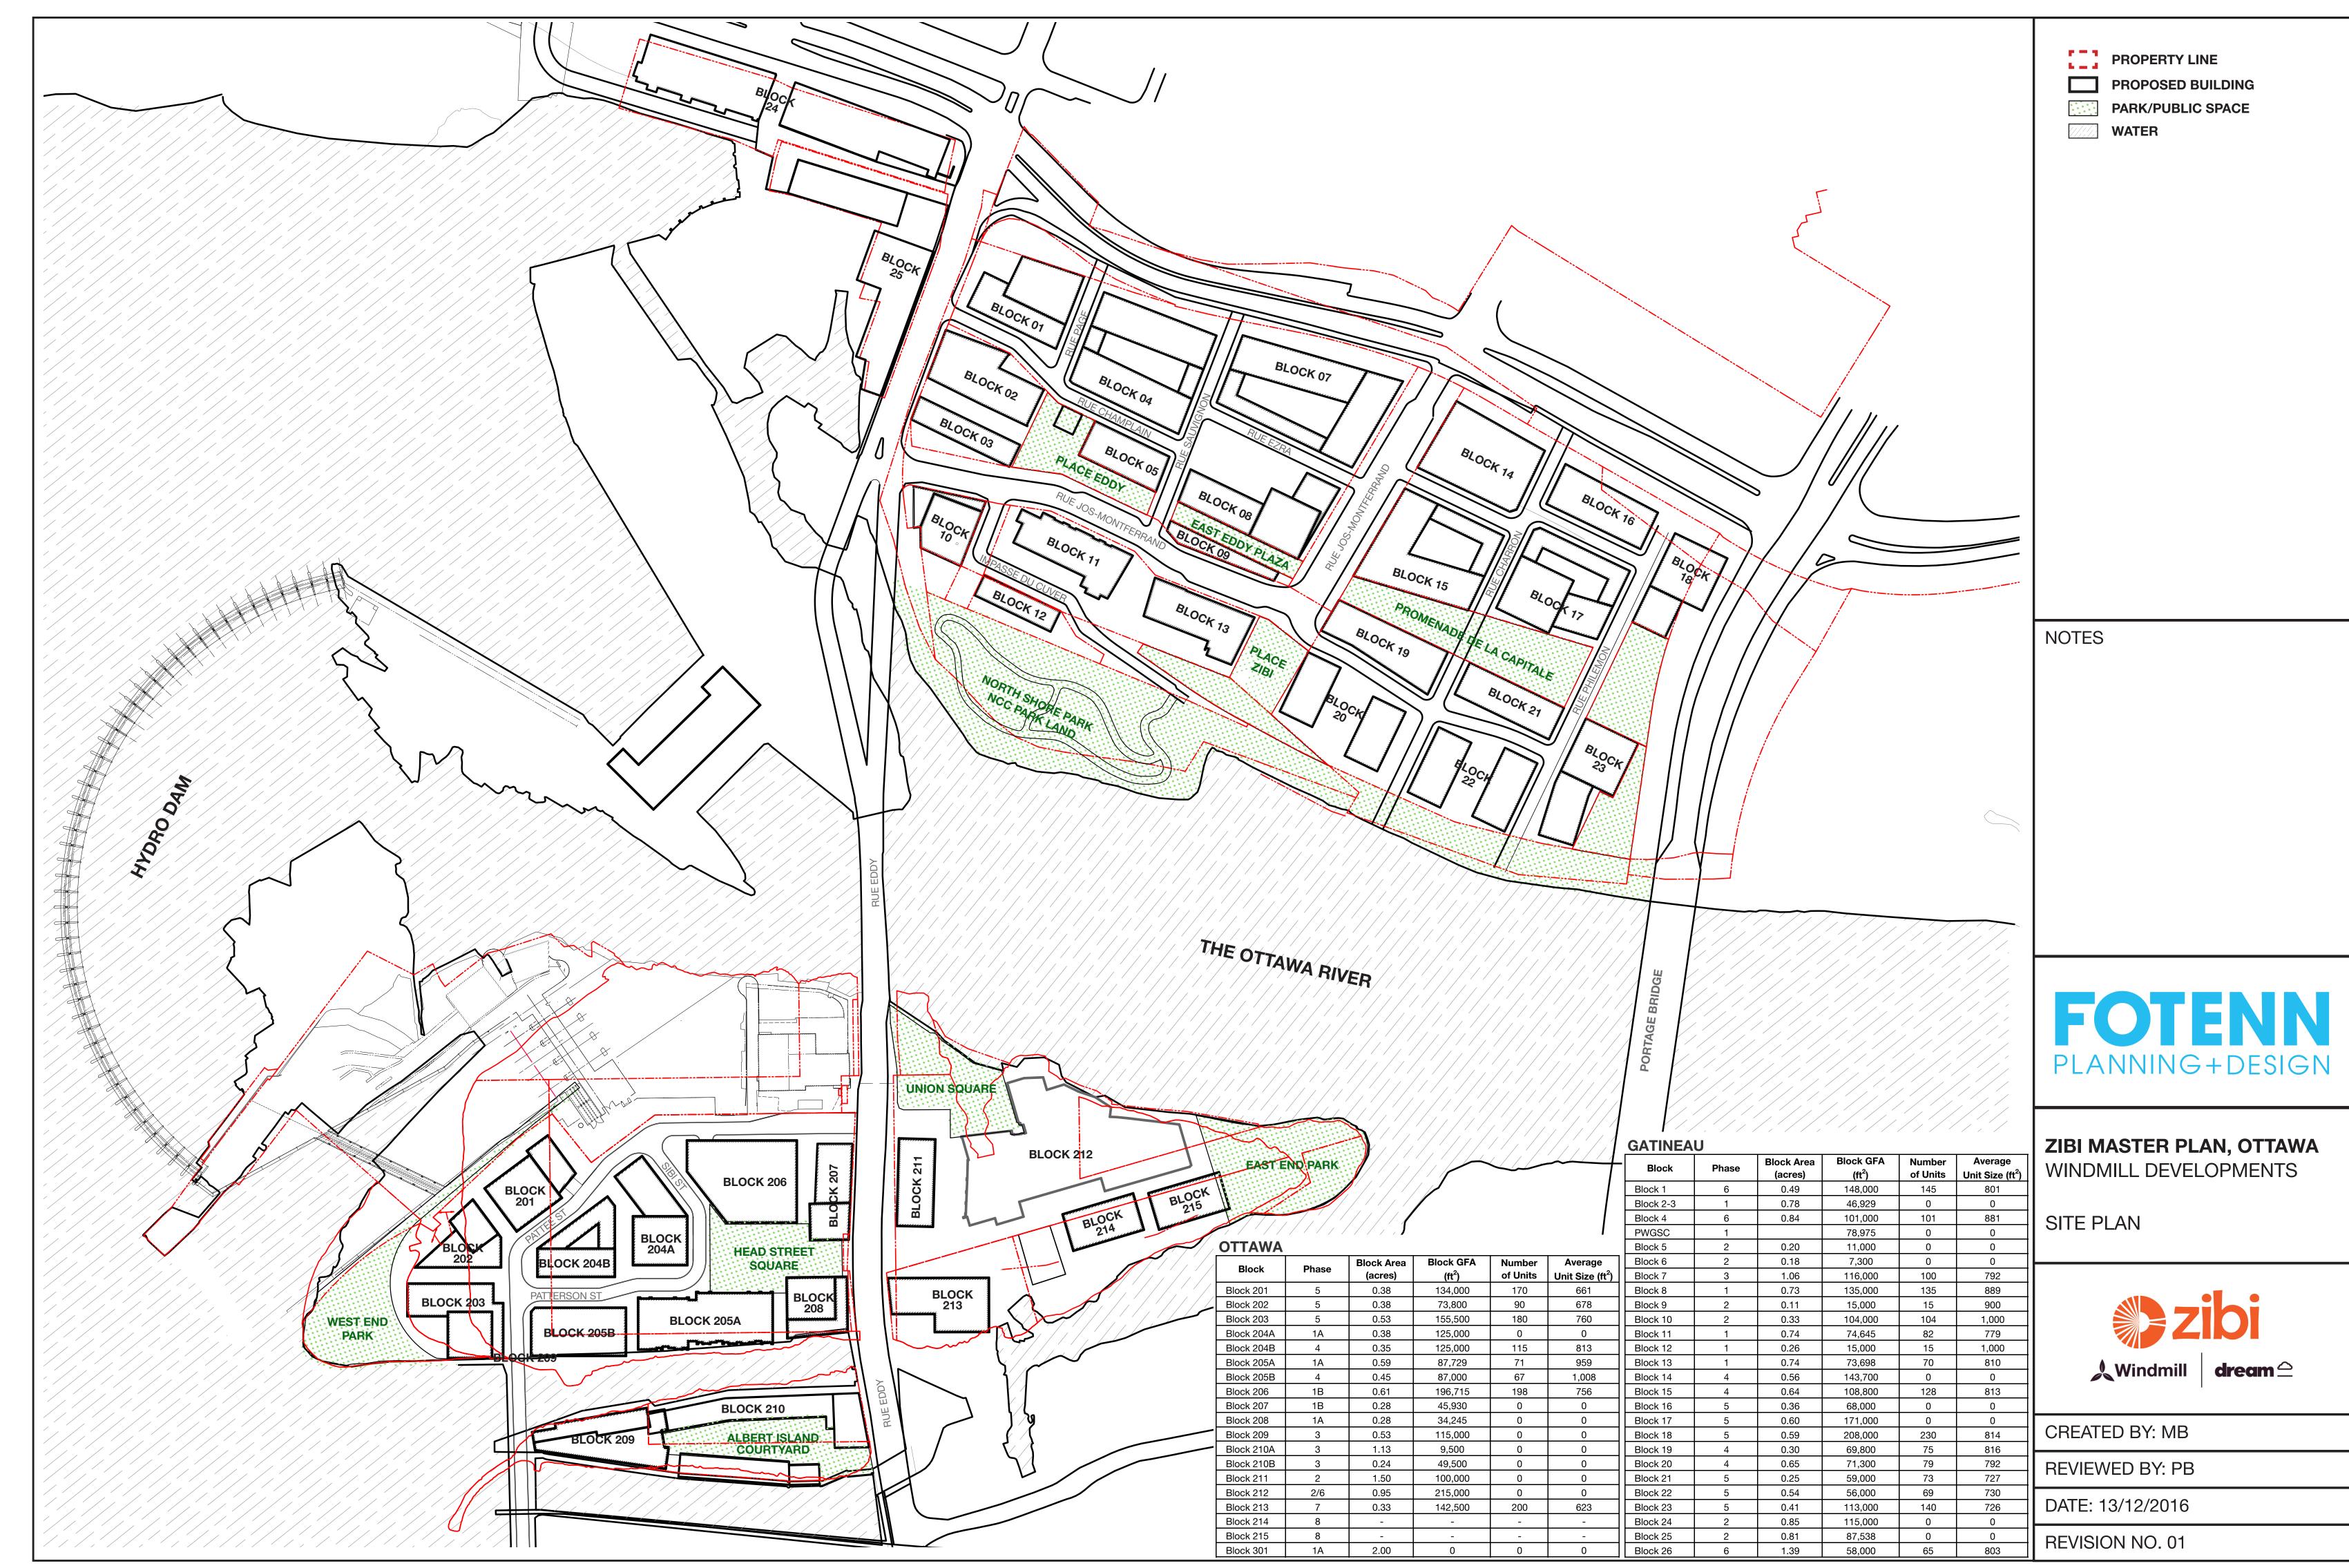

SITE STATISTICS ZONING DESIGNATION: <u>LOT AREA</u> <u>FRONTAGE</u> NORTH: 26.77 m **GROSS FLOOR AREA RESTAURANT:** LOWER LEVEL 1 **UPPER LEVEL 1** LEVEL 2 **RESTAURANT TOTAL: RETAIL:** LEVEL 1 **RETAIL TOTAL:** OFFICE: LEVEL 2 LEVEL 3 LEVEL 4 LEVEL 5 LEVEL 6 OFFICE TOTAL: <u>TOTAL:</u> **BUILDING INFORMATION:** COVERAGE: BUILDING COVERAGE: PAVING (HARDSCAPING): LANDSCAPING (SOFTSCAPING): FSI (FLOOR SPACE INDEX): No. OF STOREYS: HEIGHT: PARKING SPACE RATES: MAXIMUM COMM. PARKING RATES RETAIL : 1.0/100sm OFFICE : 1.0/100sm **RESTAURANT : NONE** PARKING SPACES: REQUIRED STALL DIMENSION 5.2m x 2.6r DRIVE AISLE WIDTH 6m RETAIL: OFFICE: 50 <u>RESTAURANT:</u> 0 TOTAL SPACES: 56 **BICYCLE PARKING SPACES:** COMM. BICYCLE PARKING RATES B **RETAIL/OFFICE/RESTAURANT: 1/25** TOTAL SPACES: NOTE: 50% CAN BE VERTICAL LOADING SPACES: COMMERCIAL: SURVEY INFORMATION: PLAN SURVEY PART OF THE BED O ADJACENT TO CHAUDIERE ISLAND FRONT OF LOT 40 CONCESSION A WATER LOT LOCATION CL4467) REGISTERED PLAN XXXX CITY OF OTTAWA PREPARED BY: SURVEYOR STANTEC GROMATICS LTD. 1331 CLYDE AVENUE, SUITE 400 OTTAWA. ONTARIO, K2C 3G4

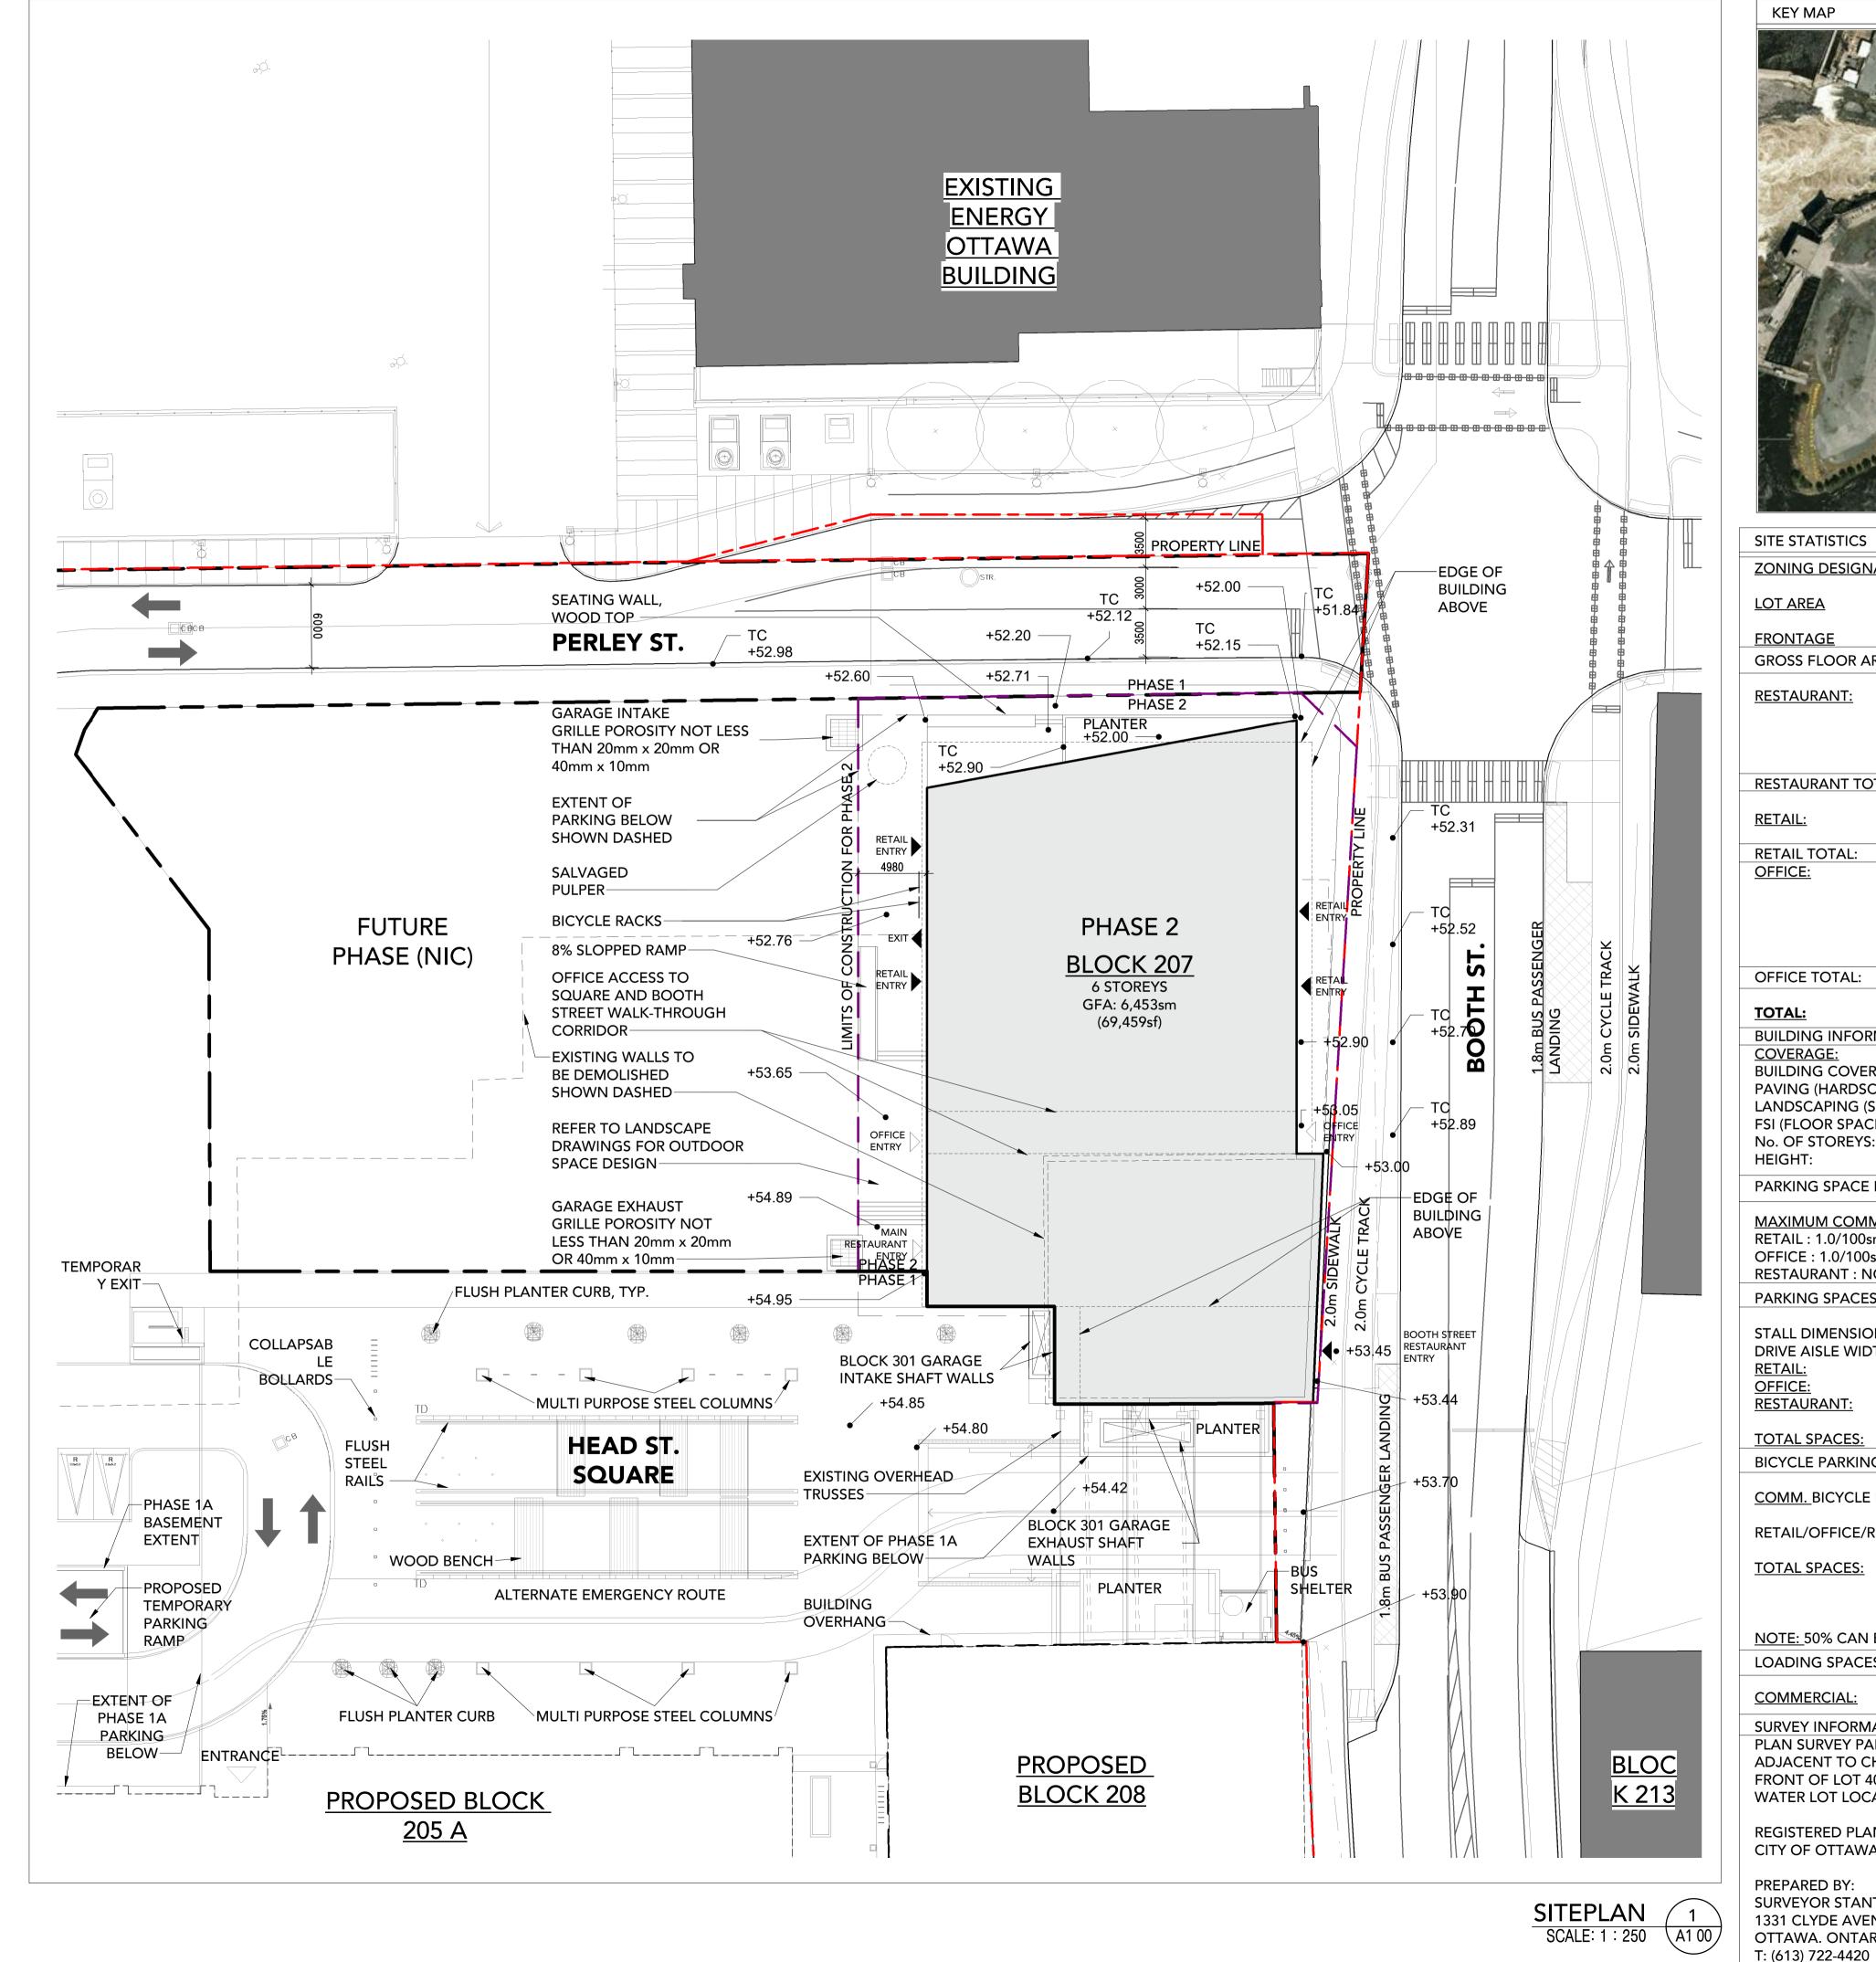

MD5[217	215332-h					
-	2,0002 11					
1,673 sm (0.41 ac)						
EAST: 49	.44 m					
AREA(sm) AREA (sf)					
215sm	(2,313sf)					
219sm 137sm	(2,362sf) (1,475sf)					
210sm	(1,47,551) (2,257sf)					
781sm	(8,408sf)					
644sm	(6,928sf)					
644sm	(6,928sf)					
770sm	(8,283sf)					
1,122sm	(12,081sf)					
1,045sm	(11,253sf)					
1,045sm	(11,253sf)					
1,045sm	(11,253sf)					
5,028sm	(54,119sf)					
<u>6,453sm</u>	<u>(69,459sf)</u>					
73% PAVING AREA/LOT AREA LANDSCAPE AREA/ LOT AREA 3.86						
6 25.65 m (TO T/O MAIN ROOF)					
BASED ON	I ZONING BY-LAW 2008-250					
	I ZONING BY-LAW 2008-250 ED PROP. B/F PROP. B/F					
PROPOS						
PROPOS n 5.2m x 2. 6m 6 50	ED PROP. B/F PROP. B/F 6m 5.2m x 2.4m 5.2m x 3.4m					
PROPOS 5.2m x 2. 6m 6 50 12 68 TOTA	ED PROP. B/F PROP. B/F 6m 5.2m x 2.4m 5.2m x 3.4m					
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PROPOS 5.2m x 2. 6m 6 50 12 68 TOTA REQUIRE ASED ON 2 0sm of GFA 26	ED PROP. B/F PROP. B/F 6m 5.2m x 2.4m 5.2m x 3.4m L 2 1 D PROPOSED CONING BY-LAW 2008-250 A 32 -14 OUTDOOR -18 INDOOR					
PROPOS 5.2m x 2. 6m 6 50 12 68 TOTA REQUIRE ASED ON 2 0sm of GFA 26	ED PROP. B/F PROP. B/F 6m 5.2m x 2.4m 5.2m x 3.4m L 2 1 ED PROPOSED CONING BY-LAW 2008-250 A 32 -14 OUTDOOR					
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THIS ____ DAY OF

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., 20_____

DOUGLAS JAMES, MCIP, RPP, MANAGER DEVELOPMENT REVIEW CENTRAL PLANNING, INFRASTRUCTURE AND ECONOMIC DEVELOPMENT DEPARTMENT, CITY OF OTTAWA




ZIBI ONTARIO BLOCK 207

ZIBI

BOOTH STREET CHAUDIERE ISLAND

OTTAWA		ONTARIO
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Drawn By: I M	Checked By: CHK	Project No. 15-122
Date Plotted: 2019-03-06 4:	12:33 PM	_{Scale:} As indicated
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F: (613) 722-2799



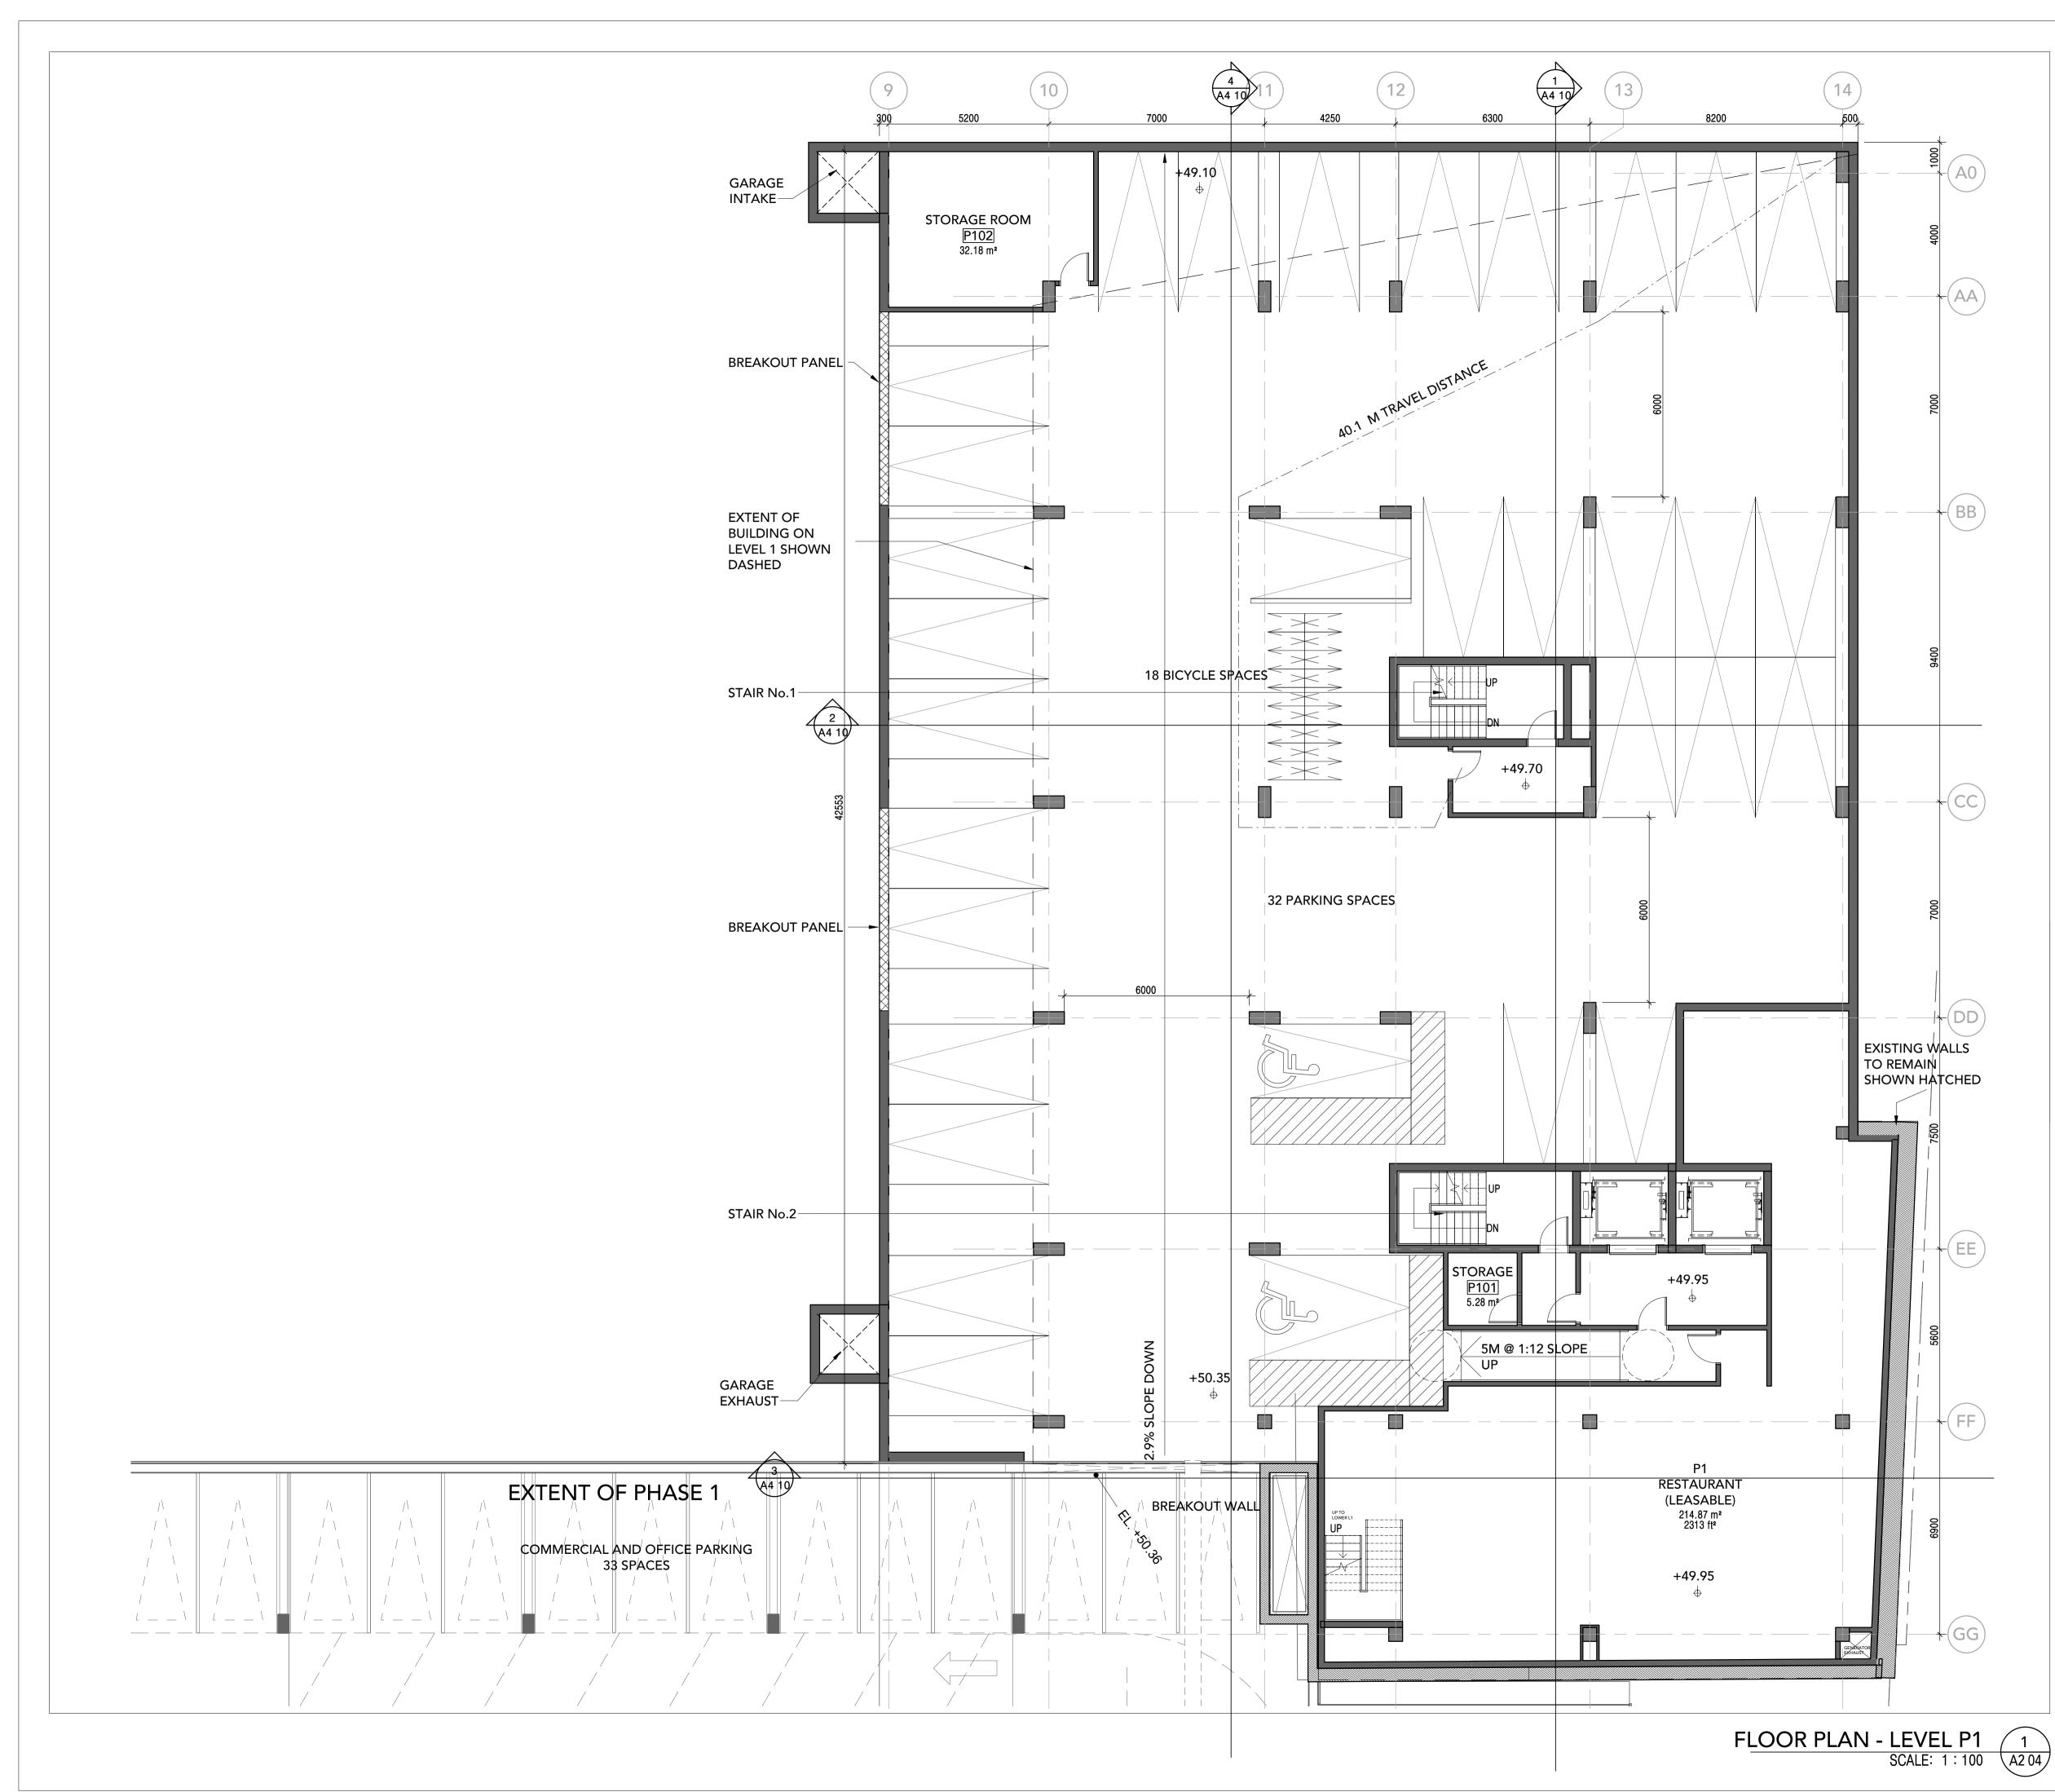

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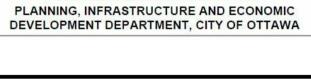


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_, 20____

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Project: ZIBI ONTARIO BLOCK 207

ZIBI

OTTAWA

Drawing Title:

Drawn By:

Date Plotted:

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P1 ENLARGED DRAWING

Checked By:

Checker

A2

BOOTH STREET CHAUDIERE ISLAND

ONTARIO


Project No. 15-122

Scale: 1:100

Drawing No.:

04

GARAGE INTAKE SHAFT GRILLE EXTENT OF PARKING BELOW SHOWN DASHED
FUTURE PHASE (N.I.C.)
REFER TO LANDSCAPE DRAWINGS FOR OUTDOOR SPACE DESIGN
FUTURE PHASE (N.I.C.) PHASE 1 (N.I.C.) GARAGE EXHAUST SHAFT GRILLE

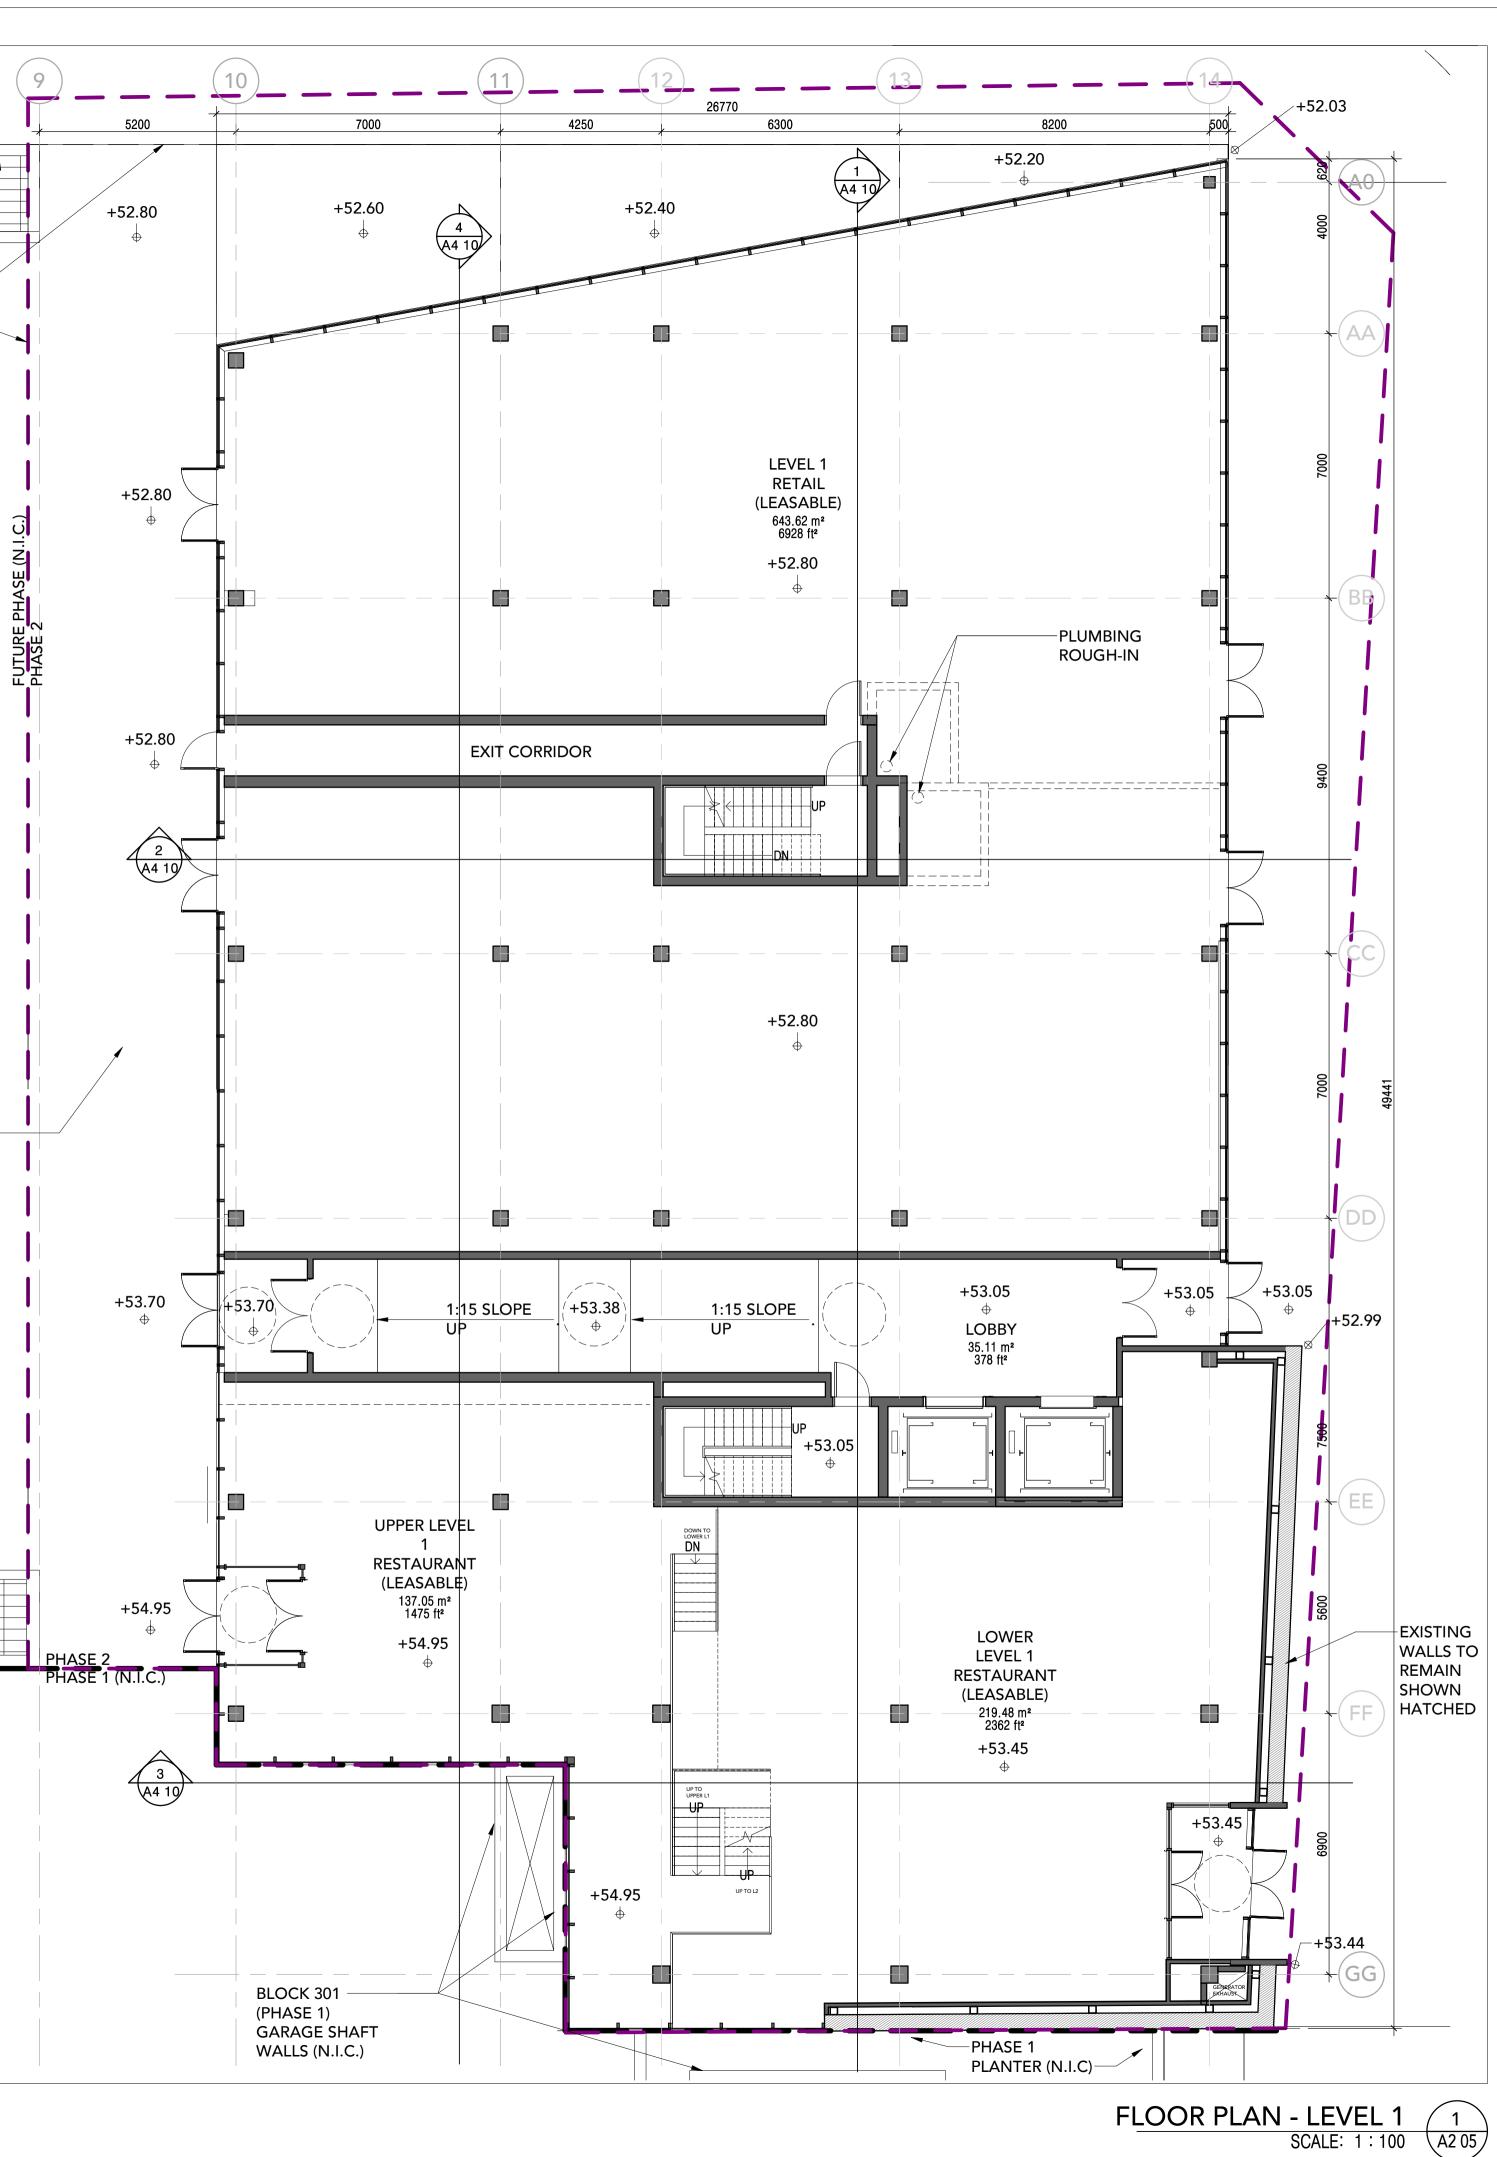



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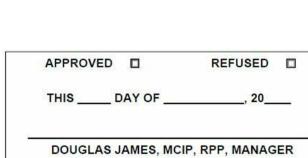
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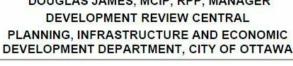
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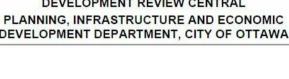



DEVELOPMENT REVIEW CENTRAL



PLANNING, INFRASTRUCTURE AND ECONOMIC DEVELOPMENT DEPARTMENT, CITY OF OTTAWA





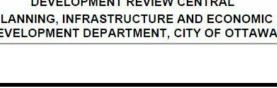





SEAL

ONTARIO

Project No. 15-122

Scale: 1:100

Drawing No.:

A2 05

Project: ZIBI ONTARIO BLOCK 207

BOOTH STREET CHAUDIERE ISLAND

LEVEL 1 FLOOR PLAN

Checked By:

Checker



ZIBI



OTTAWA

Drawing Title:

Drawn By:

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