



HOMESTEAD

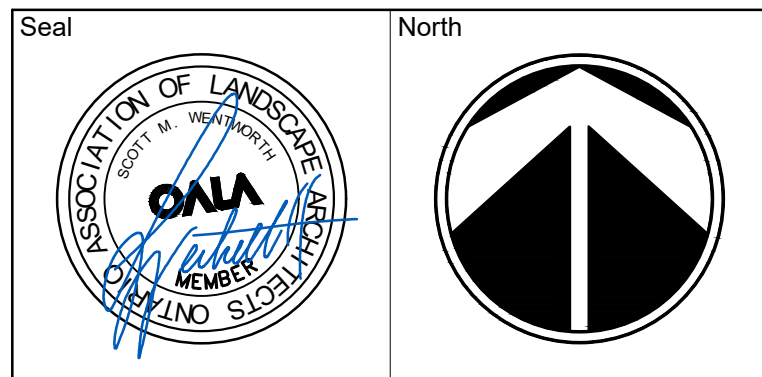

No.	Issues and Revisions	Date
1.0	REVIEW	2017-09-26
2.0	SUBMISSION	2017-10-02
3.0	RESUBMISSION	2018-06-27

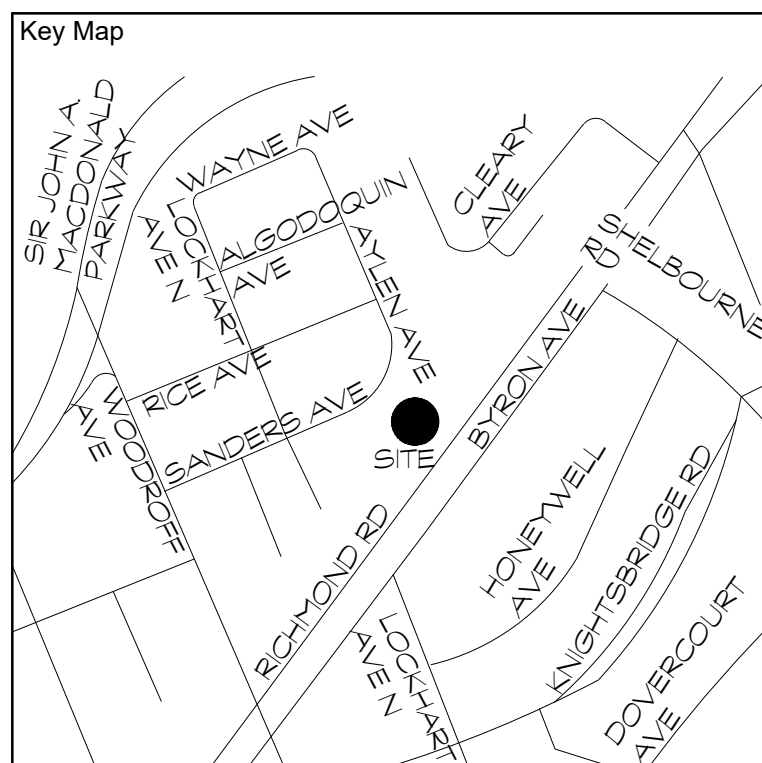

Project Notes
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Base plan information taken from Site Plan provided by:
Company Name: Roderick Lahey Architect Inc.
Dated: March 2018

Wentworth Landscapes
13392 Loyalist Parkway R.R.1, Picton ON K0K 2T0
613.547.3772

Consultants



Client
HOMESTEAD LAND HOLDINGS LIMITED


Project
851 RICHMOND ROAD

Project Location
851 RICHMOND ROAD
OTTAWA, ON


Drawing Title
SITE LANDSCAPE PLAN

Scale 1:200	Plot Date 2018-06-28
Date 2017-09-18	Drawn By DD
Designed By TG	Drawing Number
Approved By SW	
Project Number 17029	

L1

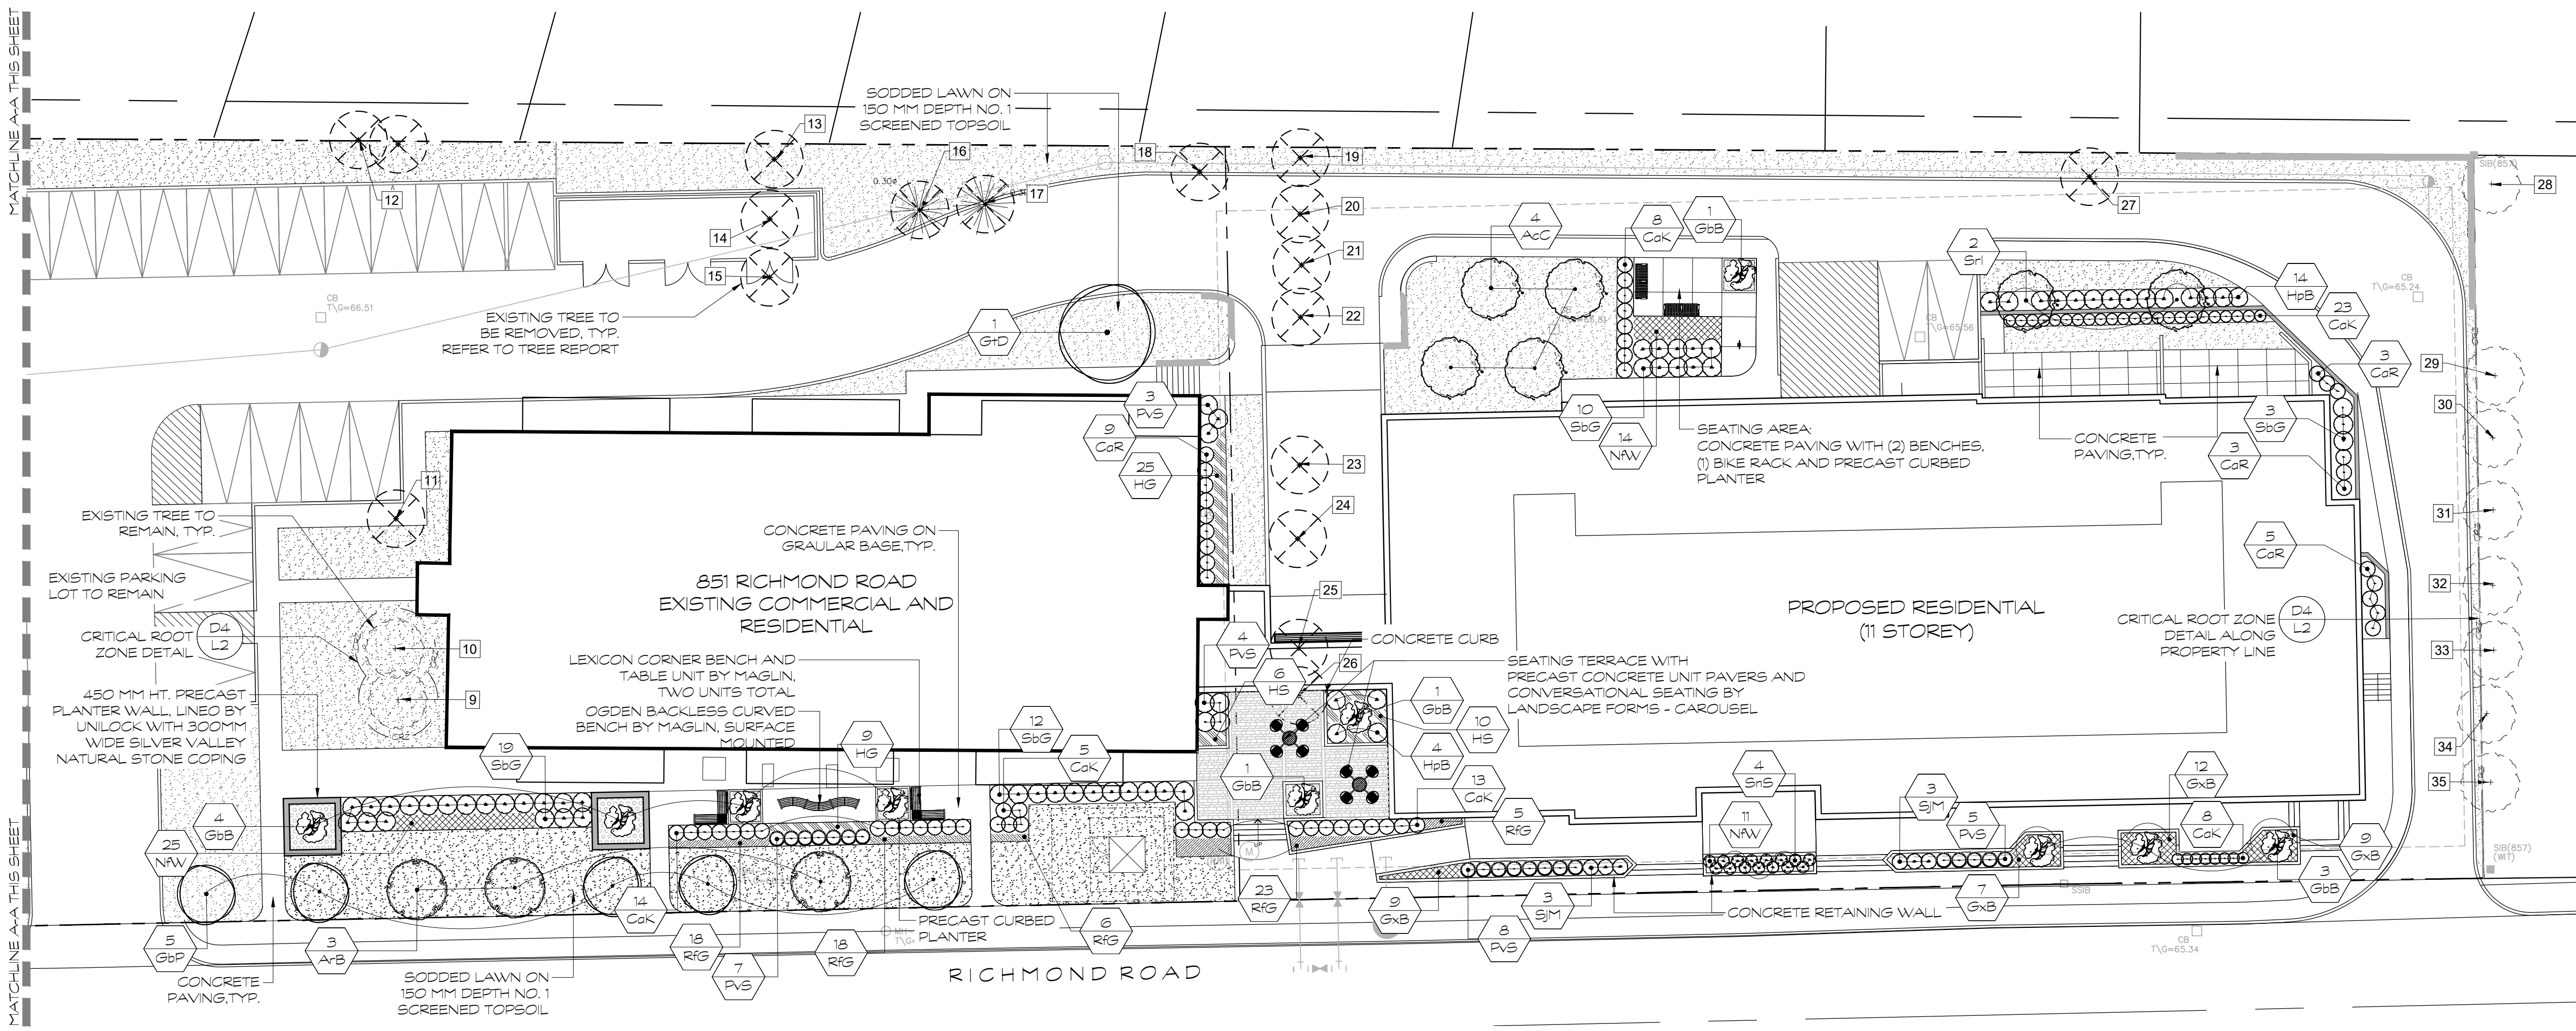

SYMBOL	QUANTITY	BOTANICAL NAME	COMMON NAME	SIZE	CONDITION	REMARKS
Deciduous and Coniferous Trees						
A-B	5	Acer rubrum Bowhall	Bowhall Red Maple	60mm	GT	
G-B	7	Ginkgo biloba Princeton Sentry	Princeton Sentry Maidenhair Tree	60mm	WB	
G-D	1	Gleditsia triacanthos Drowns	Street Keeper Honey Locust	60mm	WB	
S-B	2	Syringa reticulata Ivory Silk STD	Ivory Silk Lilac Tree STD	60mm	WB	STD
Shrubs						
A-C	4	Amelanchier canadensis Clump	Canadian Serviceberry Clump	250cm	WB	Clump
C-R	20	Clethra alnifolia Ruby Spice	Ruby Spice Summersweet	80cm	3gal	Potted
G-B	10	Ginkgo biloba Blagay	Green Spire Ginkgo	250 cm	GT	Pyramidal
H-B	18	Hydrangea paniculata Bobo	Bobo Hydrangea	60 cm	3 gal	Potted
S-G	44	Spiraea bumalda Goldflame	Goldflame Spirea	60cm	3gal	Potted
S-J	6	Spiraea japonica Magic Carpet	Magic Carpet Spirea	60cm	3gal	Potted
Herbaceous						
C-K	71	Calamagrostis acutiflora Karl Foerster	Karl Foerster Feather Reed Grass	2gal	Potted	
G-B	37	Geranium x. Brookside	Brookside Geranium	1gal	potted	
H-B	34	Hemerocallis Gemie Shepherd	Gemie Shepherd Daylily	1gal	potted	
H-B	16	Hemerocallis Stella D'Oro	Stella D'Oro Daylily	1gal	Potted	
N-W	50	Nepeta x. faassenii Walker's Low	Walker's Low Catmint	1gal	Potted	
P-V	27	Panicum virgatum Shenandoah	Shenandoah Switch Grass	2gal	Potted	
R-G	70	Rudbeckia fulgida Goldsturm	Goldsturm Black-Eyed Susan	1gal	Potted	
S-S	4	Salvia nemorosa Snow Hill	Snow Hill Sage	1gal	Potted	

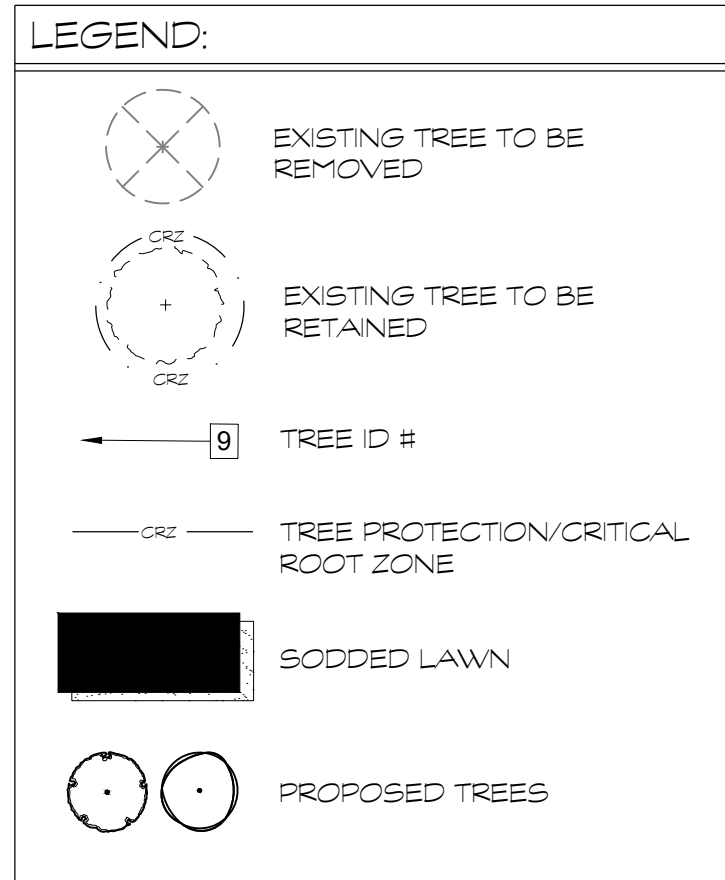


TREE INVENTORY REPORT

ID #	Botanical Name	Common Name	Diameter (cm) (Measured at 1.3m)	Condition (Good, Fair, Poor)	Proposed Impact (Remove or Retain)	Comments (Conditions, TPC treatments, etc.)
1	Acer negundo	Manitoba Maple	22-19-13	Poor	Retained	All 3 trunks with decay. Broken secondary branches in canopy.
2	Acer negundo	Manitoba Maple	17	Poor	Retained	Old injury at base of trunk with decay.
3	Ulmus americana	American Elm	36.8	Moderate	Retained	Trunk lean 10°. Epicormic shoots on trunk.
4	Acer negundo	Manitoba Maple	27.8	Poor	Retained	Trunk lean 10°. Trunk lean rolled over asphalt. Epicormic shoots on trunk.
5	Acer negundo	Manitoba Maple	32	Poor	Retained	Trunk lean 20°. Trunk lean rolled over asphalt. Epicormic shoots on trunk.
6	Acer negundo	Manitoba Maple	34.7	Poor	Retained	Hazardous tree. Fungal hollowing on trunk. Trunk lean rolled over asphalt. Epicormic shoots on trunk. 40% deadwood in canopy.
7	Acer negundo	Manitoba Maple	34-33-33.5	Poor	Retained	4-5 trunks with extensive decay. Hazardous trunk. Trunk lean rolled over asphalt. Epicormic shoots on trunk. 20% trunk lean.
8	Acer negundo	Manitoba Maple	35	Poor	Retained	Epicormic shoots on trunk. 20% trunk lean.
9	Tilia cordata	Littoral Linden	27.5	Poor	Retained	20% crown loss. Broken secondary branches in canopy. Trunk lean 10°.
10	Tilia cordata	Littoral Linden	33.8	Poor	Retained	60% canopy loss with secondary branches deadwood and decay in remaining canopy. Trunk lean 10°.
11	Tilia cordata	Littoral Linden	28.2	Moderate	Retained	Other canopy loss in pruning away from building. 20% trunk lean. Moderate scaffold structure.
12	Acer negundo	Manitoba Maple	37.9	Poor	Retained	Hazardous tree. Trunk lean 40°. Secondary branch deadwood in canopy.
13	Tilia americana	Stemmed	44	Good	Retained	Minor deadwood branches in canopy.
14	Tilia americana	Stemmed	43.3	Moderate	Retained	Primary branch union developing with included bark.
15	Tilia americana	Stemmed	36.9	Moderate	Retained	Secondary branch deadwood + 2. Minor branch deadwood in canopy. Exposed roots on base earth.
16	Prunus alba	Norway Spruce	34.4	Poor	Retained	Spore foliage. 50% leaf density.
17	Prunus alba	Norway Spruce	29.9	Poor	Retained	Spore foliage. 50% leaf density.
18	Prunus alba	Norway Spruce	35	Poor	Retained	Spore foliage. 50% leaf density.
19	Tilia cordata	Littoral Linden	31.2	Moderate	Retained	Profound canopy loss. Trunk crack from graft up to petiole. 50%.
20	Tilia cordata	Littoral Linden	31.1	Moderate	Retained	Irregular trunk form. Moderate scaffold structure.
21	Tilia cordata	Littoral Linden	35.5	Poor	Retained	Approx. top 2m of canopy is dead.
22	Tilia cordata	Littoral Linden	36.9	Poor	Retained	Irregular crown of poor structure. Lower 20% broken branches.
23	Tilia cordata	Littoral Linden	45.7	Moderate	Retained	Girdling root. Minor deadwood.

ID #	Botanical Name	Common Name	Diameter (cm) (Measured at 1.3m)	Condition (Good, Fair, Poor)	Proposed Impact (Remove or Retain)	Comments (Conditions, TPC treatments, etc.)
24	Tilia cordata	Littoral Linden	34	Moderate	Retained	Trunk form injury. Moderate scaffold structure.
25	Tilia cordata	Littoral Linden	35.7	Poor	Retained	50% of canopy is dead.
26	Tilia cordata	Littoral Linden	28.2	Poor	Retained	50% of canopy is dead.
27	Acer negundo	Manitoba Maple	36-34-8	Poor	Retained	2 stems with included bark at union. Trunk lean rolled over asphalt. Poor scaffold structure.
28	Acer negundo	Manitoba Maple	50.2	Poor	Retained	2 stems at 2m. One with early and deep weeping. Trunk lean 10° to trunk lean.
29	Ulmus punctata	Sharon Elm	53.5	Moderate	Retained	1st branch at 3m - weeping at union. Minor deadwood throughout canopy.
30	Ulmus punctata	Sharon Elm	34	Moderate	Retained	Section next to base of trunk. Co-dominant trunks beginning to lean. Minor deadwood throughout canopy.
31	Ulmus punctata	Sharon Elm	34.1	Moderate	Retained	Co-dominant trunks beginning to lean. Union with included bark. Minor deadwood throughout canopy.
32	Ulmus punctata	Sharon Elm	32.6	Moderate	Retained	Moderate scaffold branch structure. Lower deadwood branches in canopy.
33	Ulmus punctata	Sharon Elm	34.9	Moderate	Retained	Moderate scaffold branch structure. Scarier vent at base and 1st branch on one side of trunk at base. Minor deadwood branches in canopy.
34	Ulmus punctata	Sharon Elm	35.8	Moderate	Retained	Moderate scaffold branch structure. Girdling root at base of trunk. 1st branch union with included bark. Minor deadwood branches in canopy.
35	Ulmus punctata	Sharon Elm	53	Moderate	Retained	


APPROVED
By Laurel McCreight at 9:20 am, Mar 01, 2019

DERRICK MOODIE
MANAGER
PLANNING, INFRASTRUCTURE & ECONOMIC
DEVELOPMENT DEPARTMENT, CITY OF OTTAWA

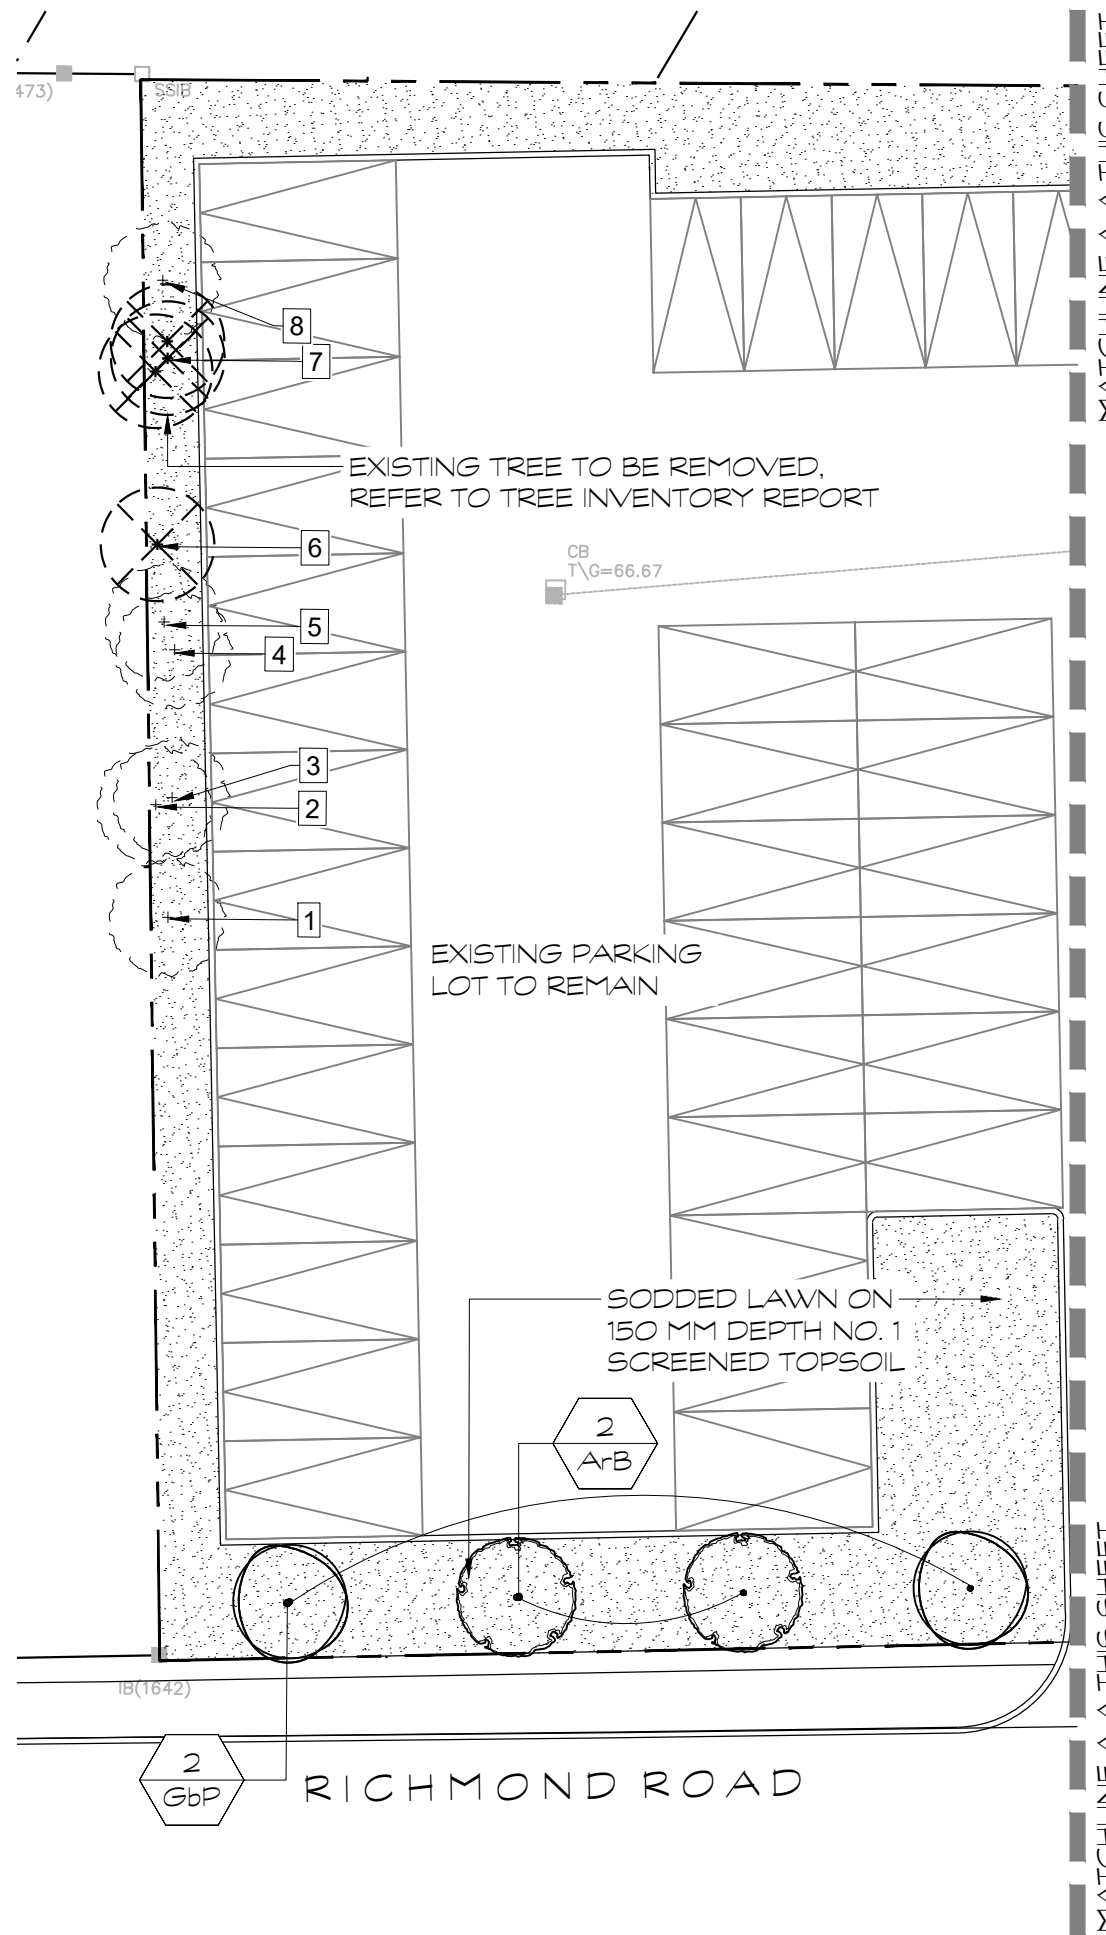

SCALE: 1:200

C:\Users\jowen\Desktop\Richmond Road\17029_12_Site Details.dwg

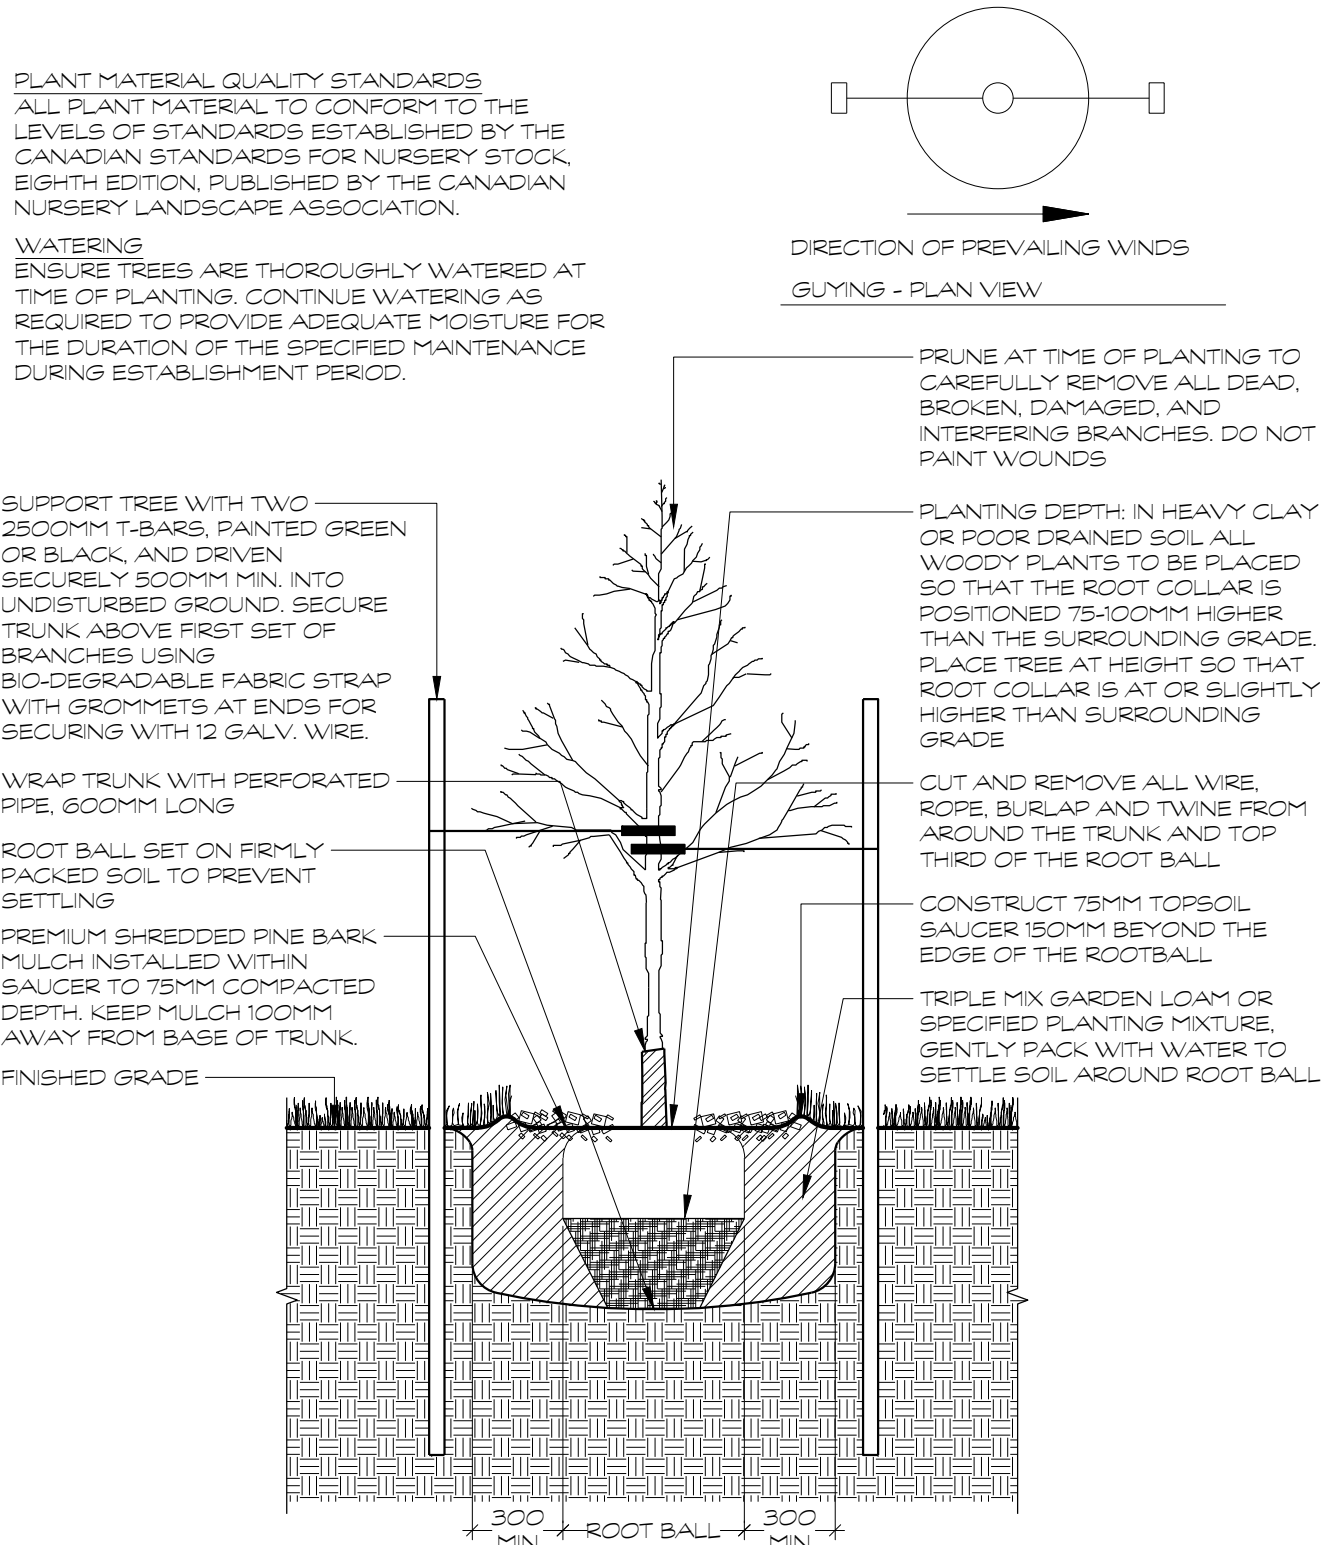


D1 DECIDUOUS TREE PLANTING
1:25

NOTES
-SHRUBS AS DETAILED REPRESENTS BOTH CONIFEROUS AND DECIDUOUS SPECIES
-PLACE MULCH TO EVEN HORIZONTAL GRADE
-SHRUBS PLANTED IN GROUPS SHALL BE SET IN CONTINUOUS PLANTING BEDS
-SHRUB BEDS TO BE BACKFILLED WITH TRIPLE MIX GARDEN LOAM PLANTING MIXTURE AS SPECIFIED TO A COMPACTED DEPTH OF 450MM
-FIRMLY COMPACTED BACKFILLED PLANTING MIXTURE TO ELIMINATE AIR POCKETS AND PREVENT SETTLEMENT

PLANT MATERIAL QUALITY STANDARDS
ALL PLANT MATERIAL TO CONFORM TO THE LEVELS OF STANDARDS ESTABLISHED BY THE CANADIAN STANDARDS FOR NURSERY STOCK, EIGHTH EDITION, PUBLISHED BY THE CANADIAN NURSERY LANDSCAPE ASSOCIATION.

WATERING
ENSURE SHRUBS ARE THOROUGHLY WATERED AT TIME OF PLANTING. CONTINUE WATERING AS REQUIRED TO PROVIDE ADEQUATE MOISTURE FOR THE DURATION OF THE SPECIFIED MAINTENANCE DURING ESTABLISHMENT PERIOD.

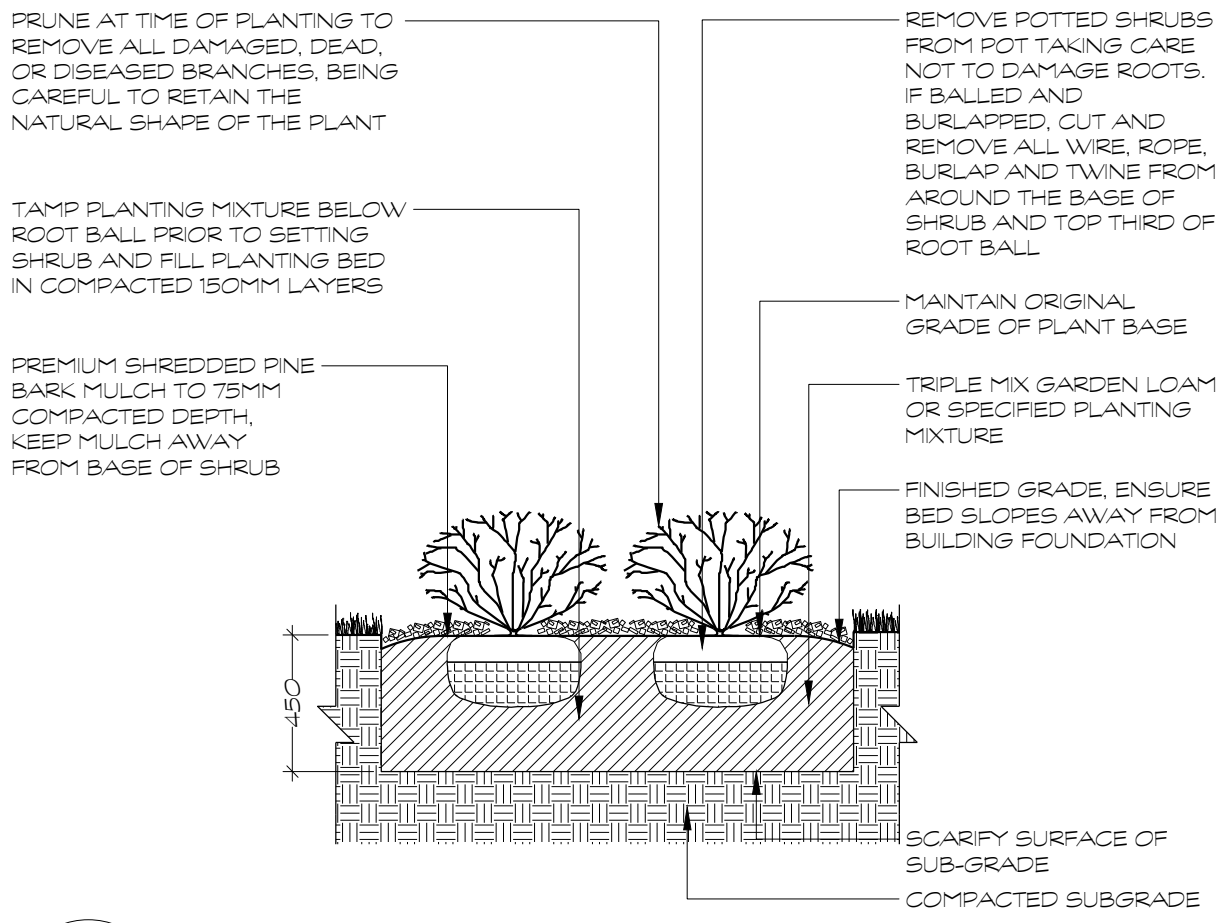


D2 SHRUB PLANTING
1:25

NOTES
-PLACE MULCH TO EVEN HORIZONTAL GRADE
-FIRMLY COMPACTED BACKFILLED TRIPLE MIX GARDEN LOAM OR SPECIFIED PLANTING MIXTURE TO ELIMINATE AIR POCKETS AND PREVENT SETTLEMENT

PLANT MATERIAL QUALITY STANDARDS
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WATERING
ENSURE HERBACEOUS PLANTS ARE THOROUGHLY WATERED AT TIME OF PLANTING. CONTINUE WATERING AS REQUIRED TO PROVIDE ADEQUATE MOISTURE FOR THE DURATION OF THE SPECIFIED MAINTENANCE DURING ESTABLISHMENT PERIOD.

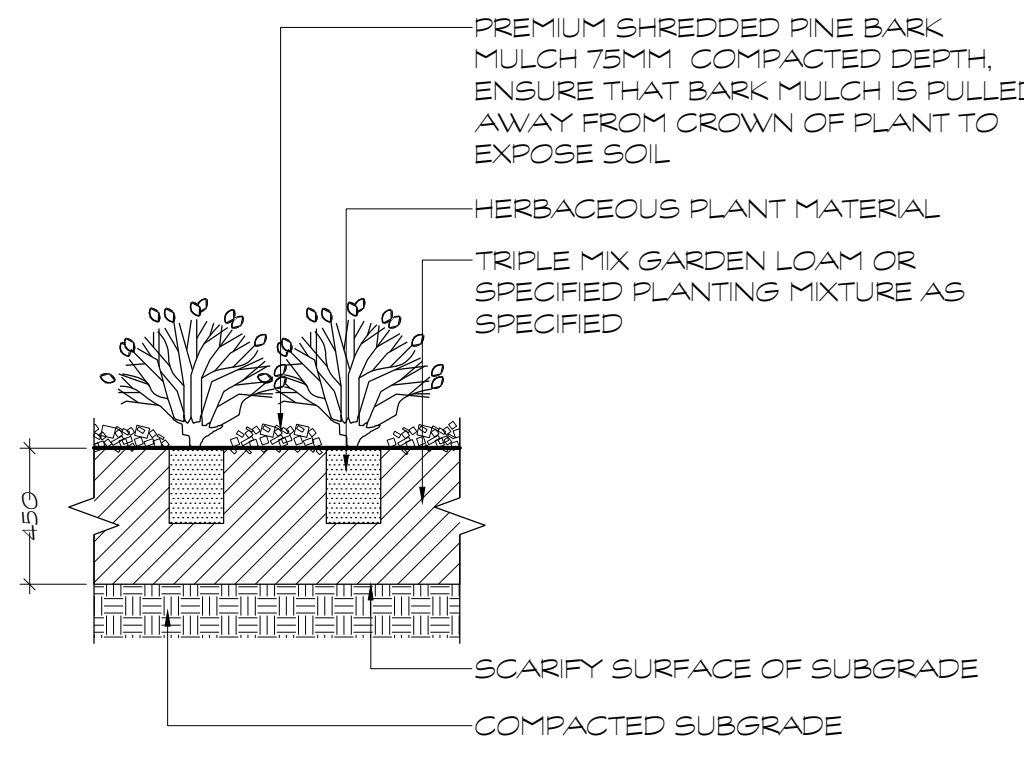

D3 HERBACEOUS PLANTING
1:25


- NOTES
1. REFER TO TREE PRESERVATION SPECIFICATIONS
 2. MAINTAIN CRZ CONSTRUCTION FENCING IN PLACE FOR THE ENTIRE DURATION OF CONSTRUCTION
 3. ALL CRZ FENCING SHALL BE IN PLACE PRIOR TO ANY SITE ALTERATIONS/CONSTRUCTION ACTIVITY AND TO BE MAINTAINED TO SPECIFICATION THROUGHOUT THE PROJECT UP TO AND INCLUDING THE COMPLETION OF ALL LANDSCAPE TREATMENTS
 4. NO PERSON OR CONTRACTOR SHALL ENTER, MOVE OR ADJUST THE CRZ ONCE THE FENCING HAS BEEN ERECTED. THE CRZ SHALL NOT BE REMOVED UNTIL THE COMPLETION OF THE PROJECT.
 5. DO NOT ATTACH SIGNS OR POSTERS TO THE TREE.
 6. DO NOT PLACE ANY MATERIAL OR EQUIPMENT WITHIN THE CRZ FENCING.
 7. DO NOT RAISE OR LOWER THE EXISTING GRADE WITHIN THE CRZ OF THE TREE WITHOUT APPROVAL OF FORESTRY SERVICES.
 8. DO NOT DAMAGE THE ROOT SYSTEM, TRUNK OR BRANCHES OF ANY TREE.
 9. DO NOT TUNNEL OR BORE WHEN DIGGING WITHIN THE CRZ OF ANY TREE.
 10. ENSURE THAT EXHAUST FUMES FROM ALL EQUIPMENT ARE NOT DIRECTED TOWARDS ANY TREES CANOPY.

CRITICAL ROOT ZONE SIGNAGE
A SIGN THAT IS SIMILAR TO THE ILLUSTRATION TO THE RIGHT MUST BE MOUNTED ON ALL SIDES OF A TREE PROTECTION BARRIER. THE SIGN SHOULD BE A MINIMUM OF 400MM X 600MM (15 7/8 X 23 5/8") AND MADE OF WHITE GATOR BOARD OR EQUIVALENT MATERIAL.

CRITICAL ROOT ZONE (CRZ)
NO GRADE CHANGE, STORAGE OF MATERIALS, VEHICLES OR EQUIPMENT IS PERMITTED WITHIN THIS CRZ. THIS TREE PROTECTION BARRIER MUST NOT BE REMOVED WITHOUT THE WRITTEN AUTHORIZATION OF THE CITY OF OTTAWA.


CRITICAL ROOT ZONE (CRZ)
D = DIAMETER OF TRUNK IN CENTIMETRES
D x 10 CM = CRITICAL ROOT ZONE

THE CRITICAL ROOT ZONE IS ESTABLISHED AS BEING 10CM FROM THE TRUNK OF A TREE FOR EVERY CM OF TRUNK DIAMETER. THE TRUNK DIAMETER IS MEASURED AT A HEIGHT OF 1.2M FOR TREES OF 15CM DIA. AND GREATER AND AT A HEIGHT OF 0.3M FOR TREES LESS THAN 15CM DIA.

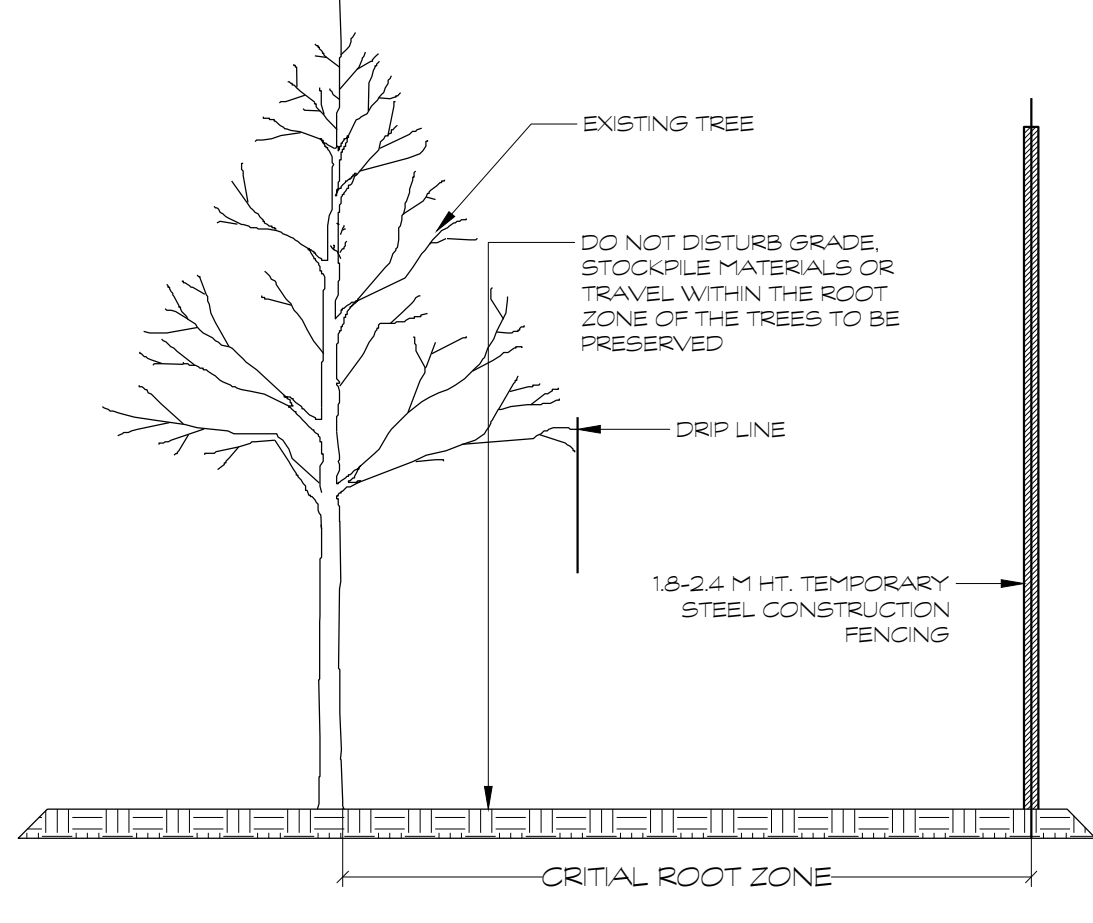

D4 TREE PROTECTION ZONE/ CRITICAL ROOT ZONE
1:25

HOMESTEAD

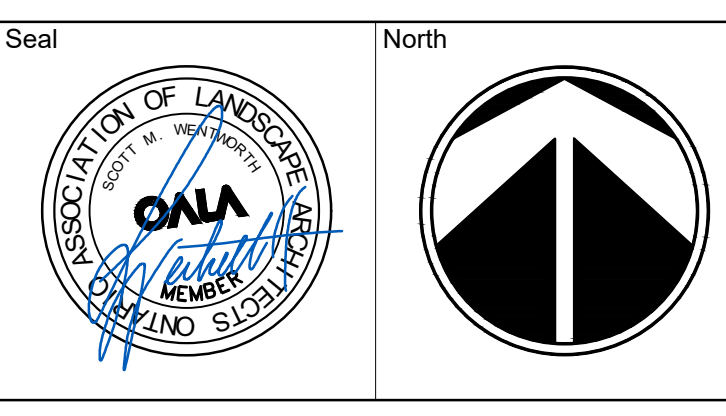

No.	Issues and Revisions	Date
1.0	REVIEW	2017-09-26
2.0	SUBMISSION	2017-10-02
3.0	RESUBMISSION	2018-06-27

Key Map

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613.547.3772

Consultants



Client	HOMESTEAD LAND HOLDINGS LIMITED
Project	851 RICHMOND ROAD
Project Location	851 RICHMOND ROAD OTTAWA, ON
Drawing Title	SITE DETAILS
Scale	AS NOTED
Date	2017-09-18
Designed By	TG
Approved By	SW
Project Number	17029
Plot Date	2018-06-27
Drawn By	DD
Drawing Number	