


MARCH 21, DST

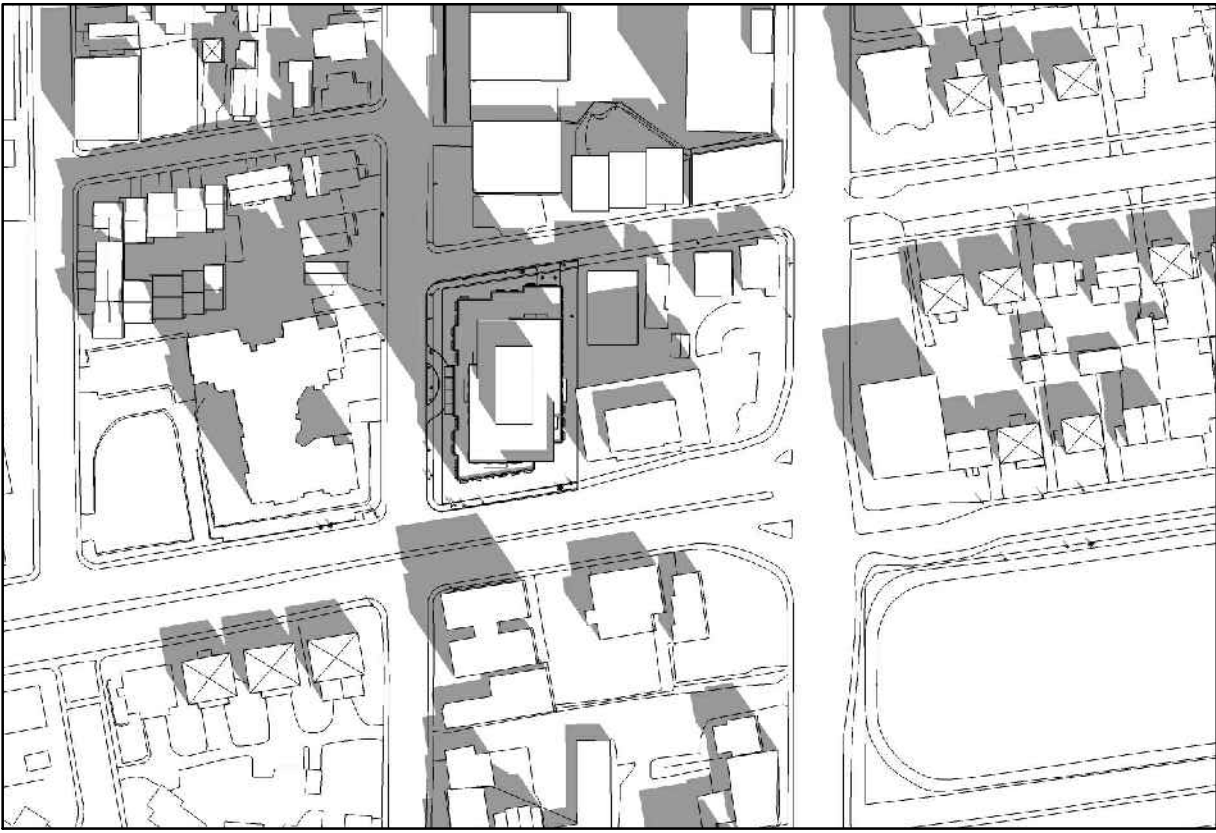


8:00 am




10:00 am



12:00 pm

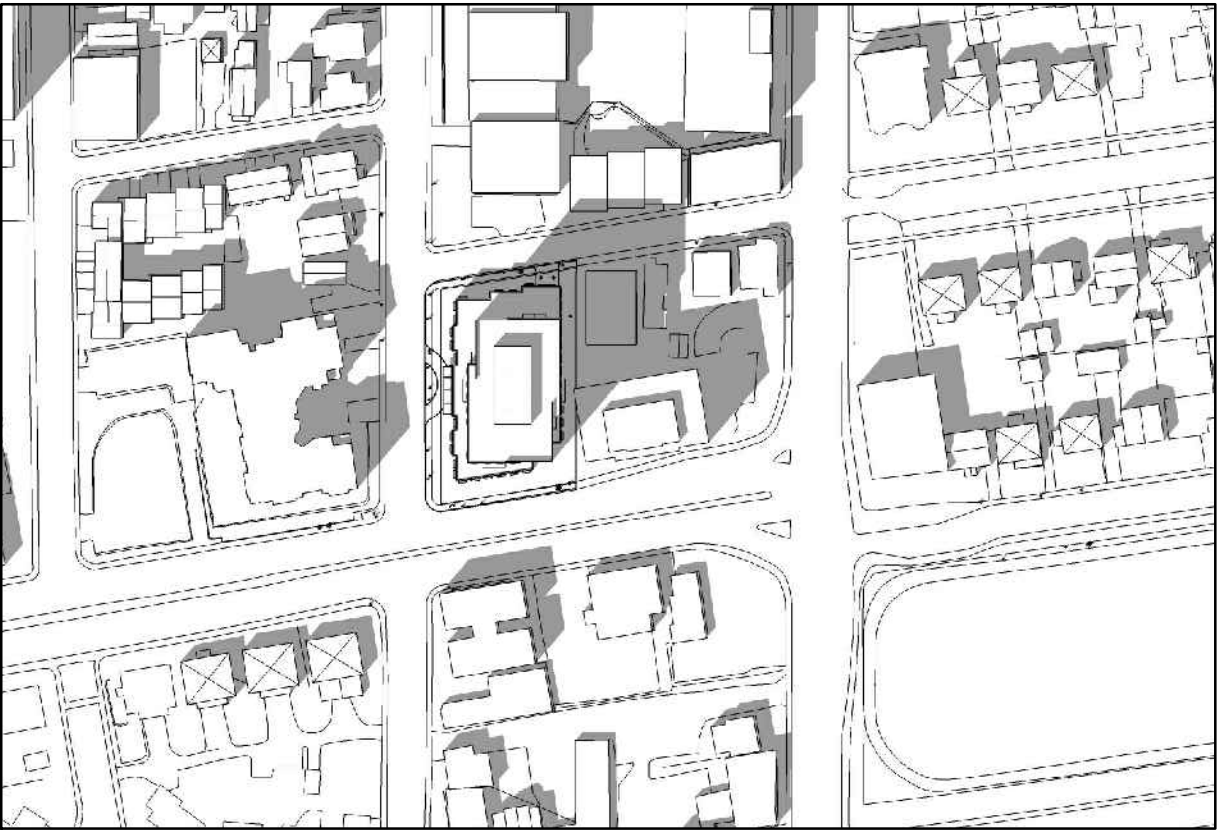

2:00 pm

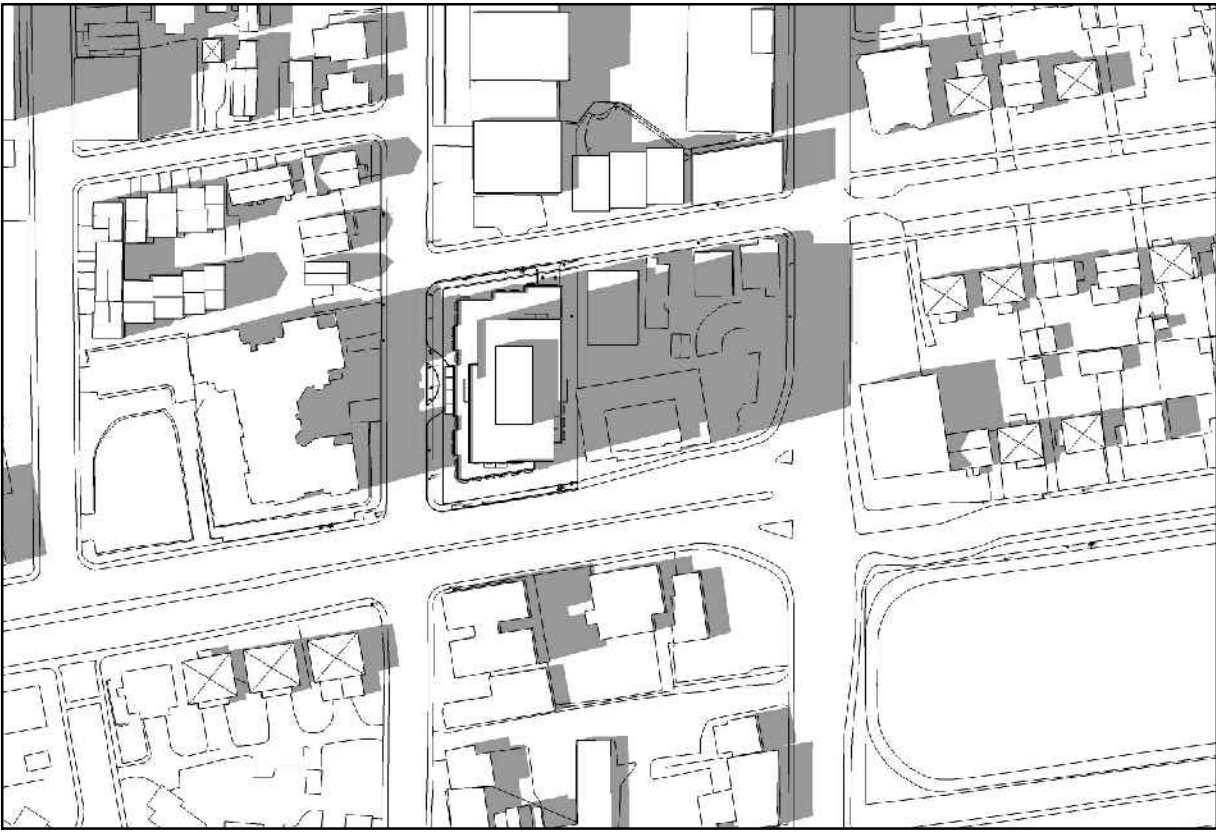


4:00 pm


JUNE 21, DST




8:00 am

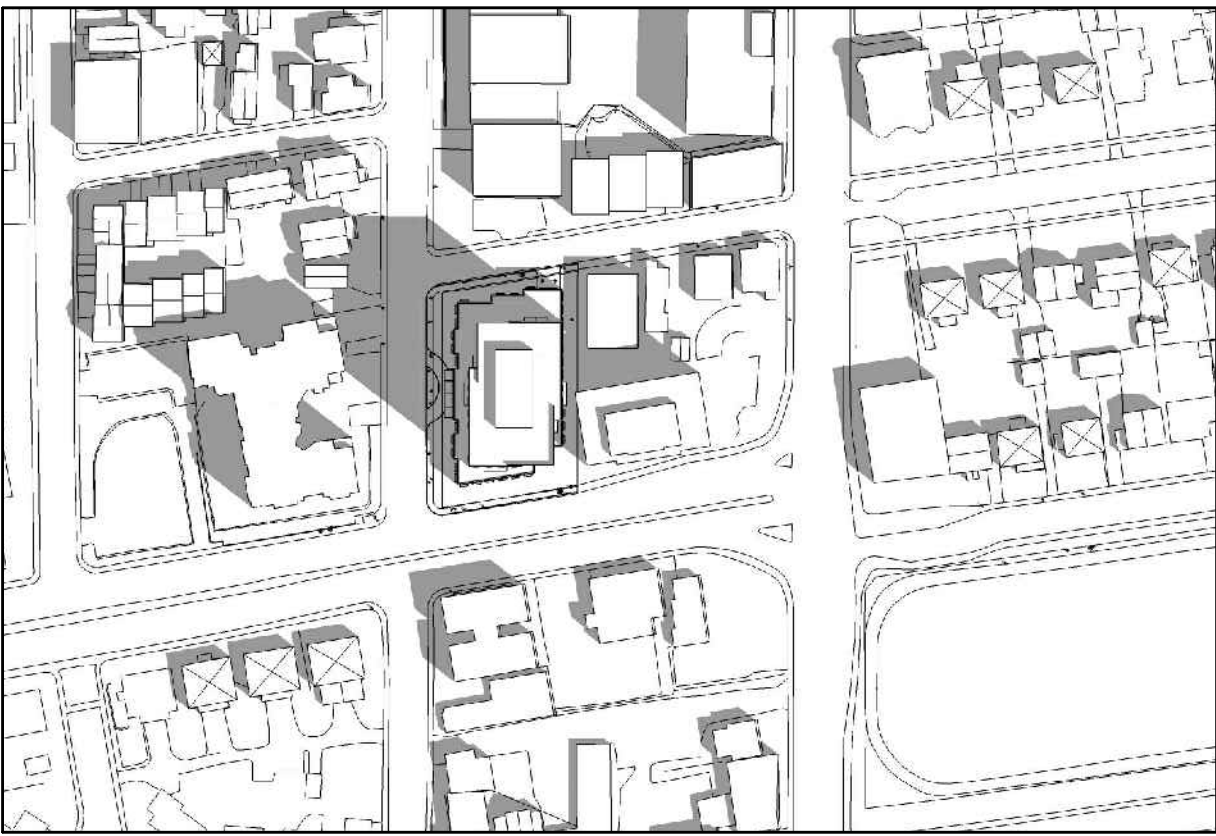

10:00 am

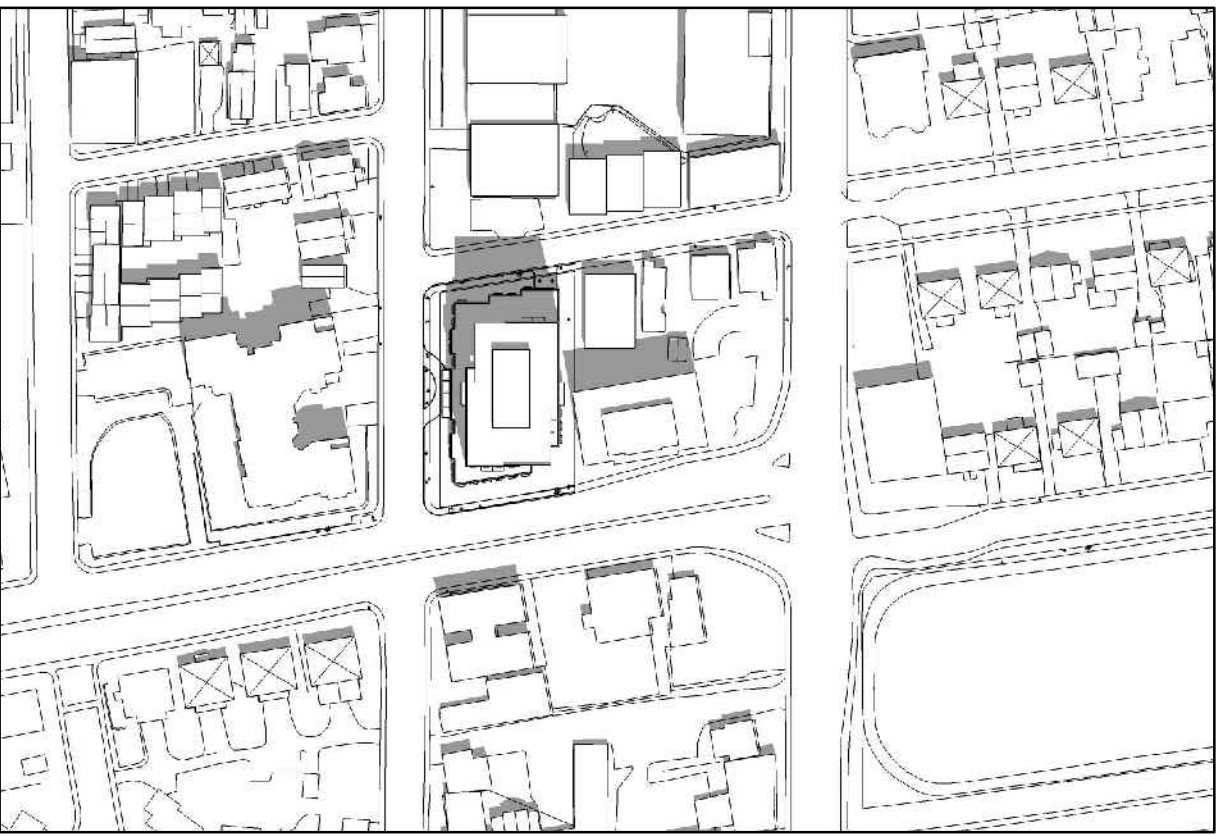

12:00 pm

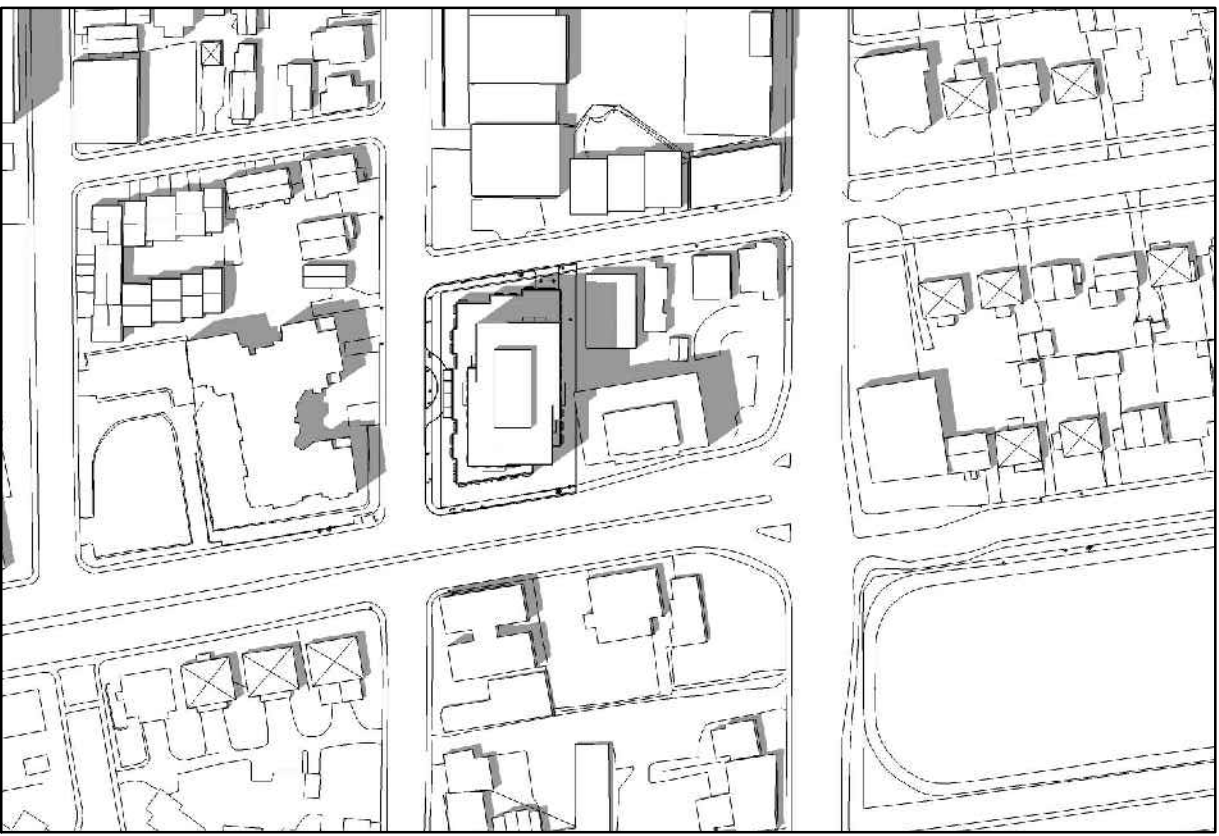


2:00 pm




4:00 pm

SEPTEMBER 21, DST

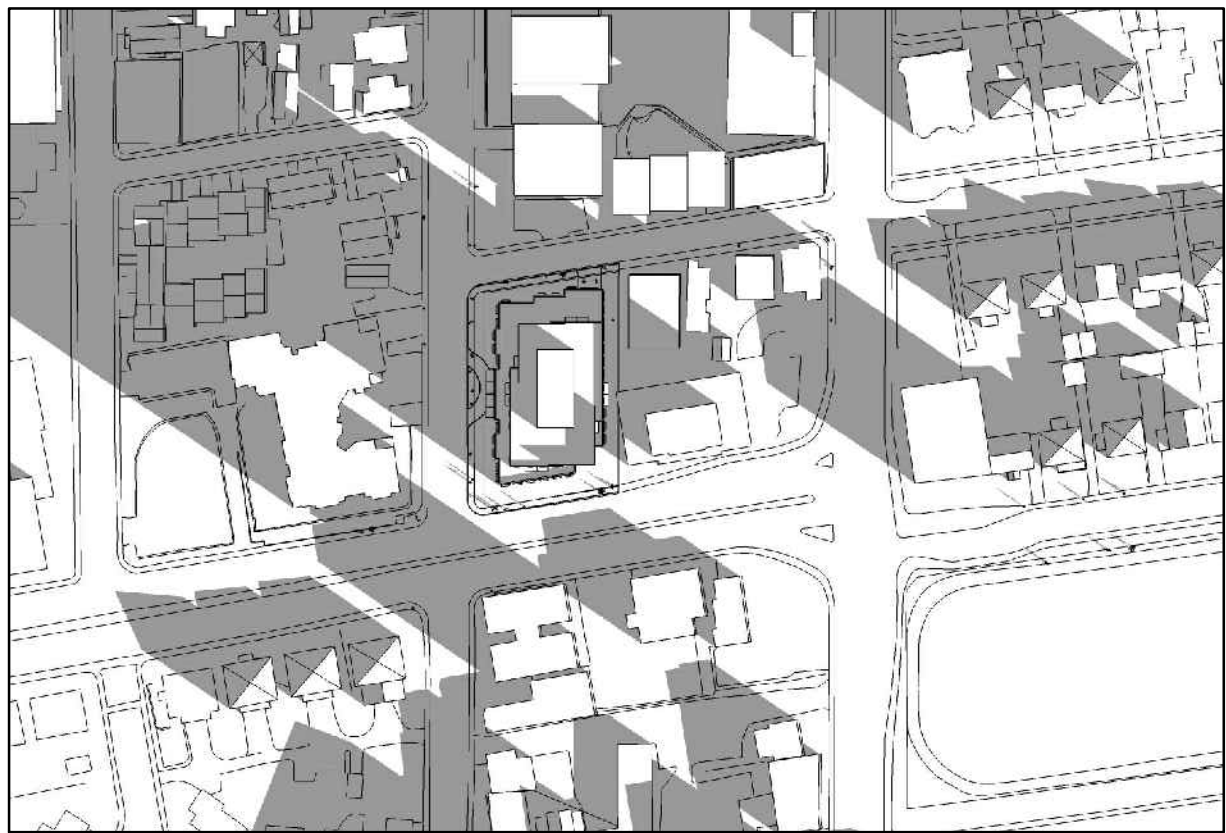


8:00 am

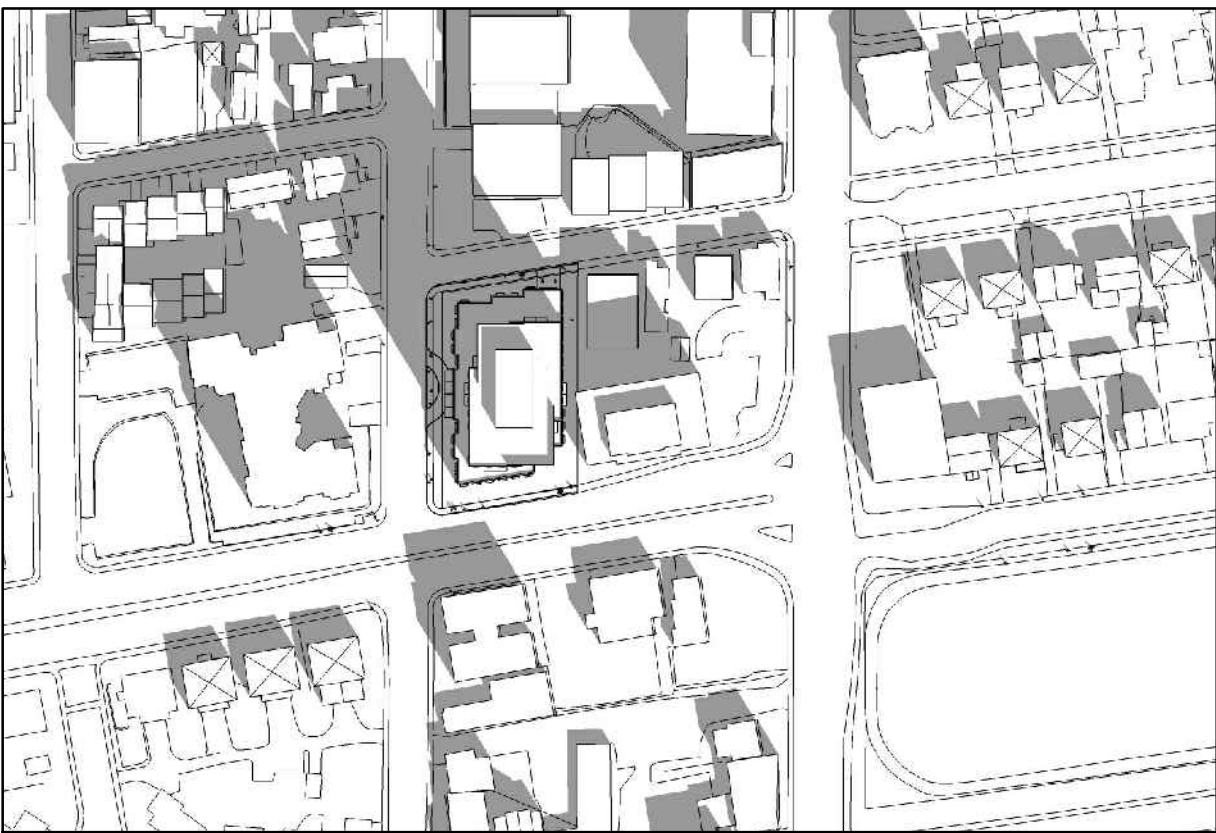


10:00 am



12:00 pm

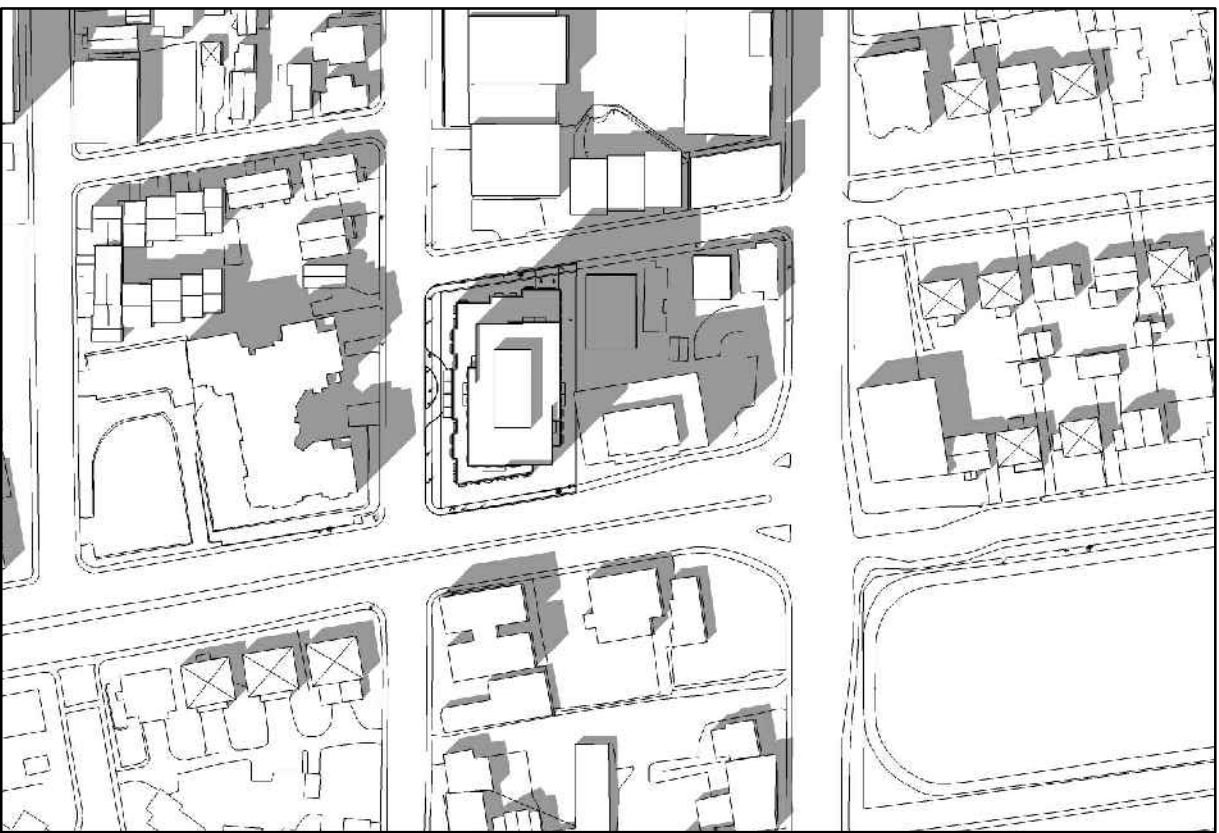


2:00 pm

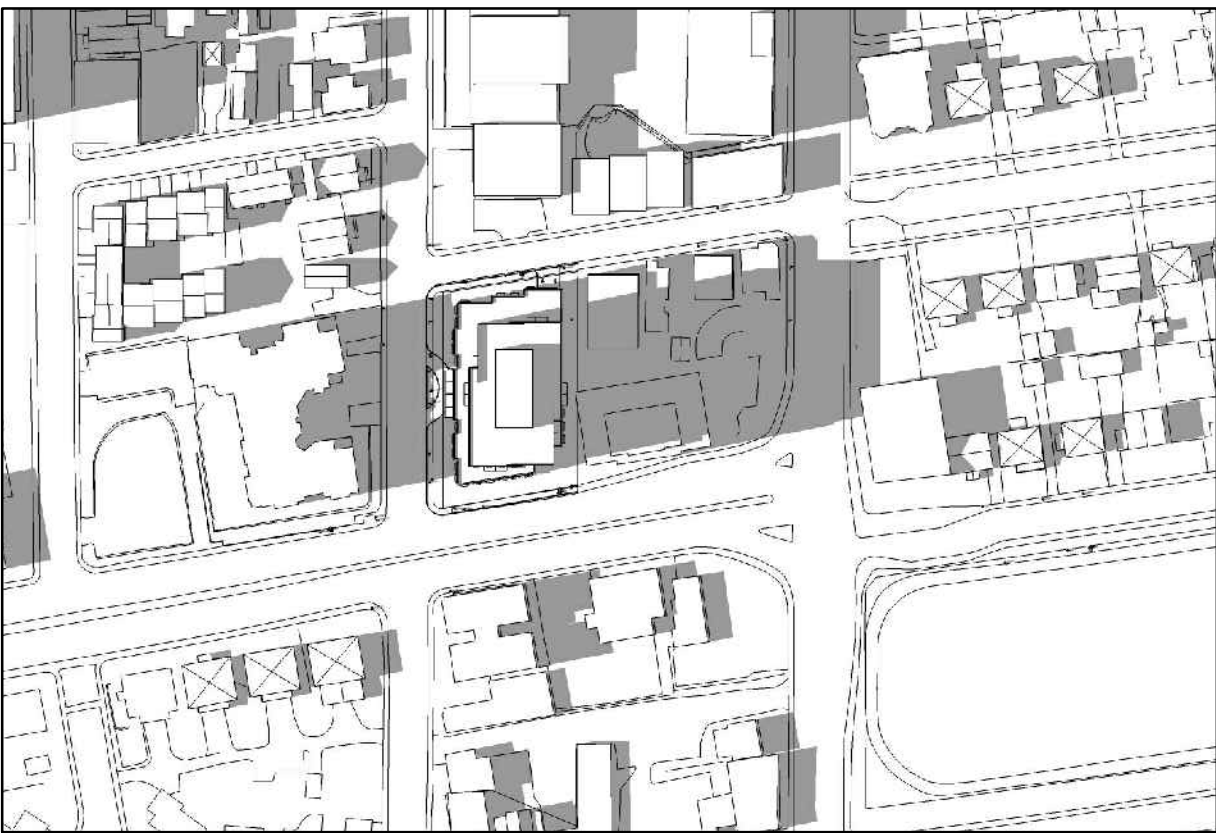


4:00 pm


DECEMBER 21

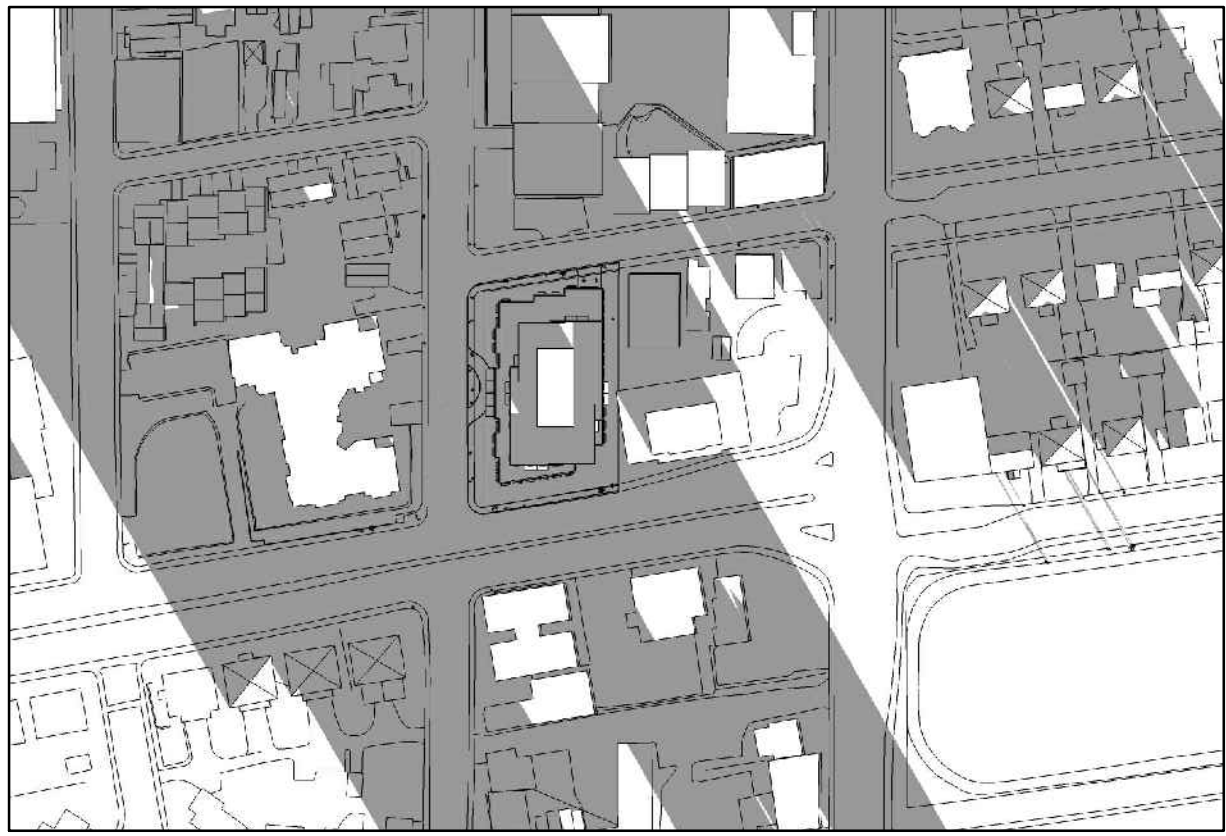


8:00 am

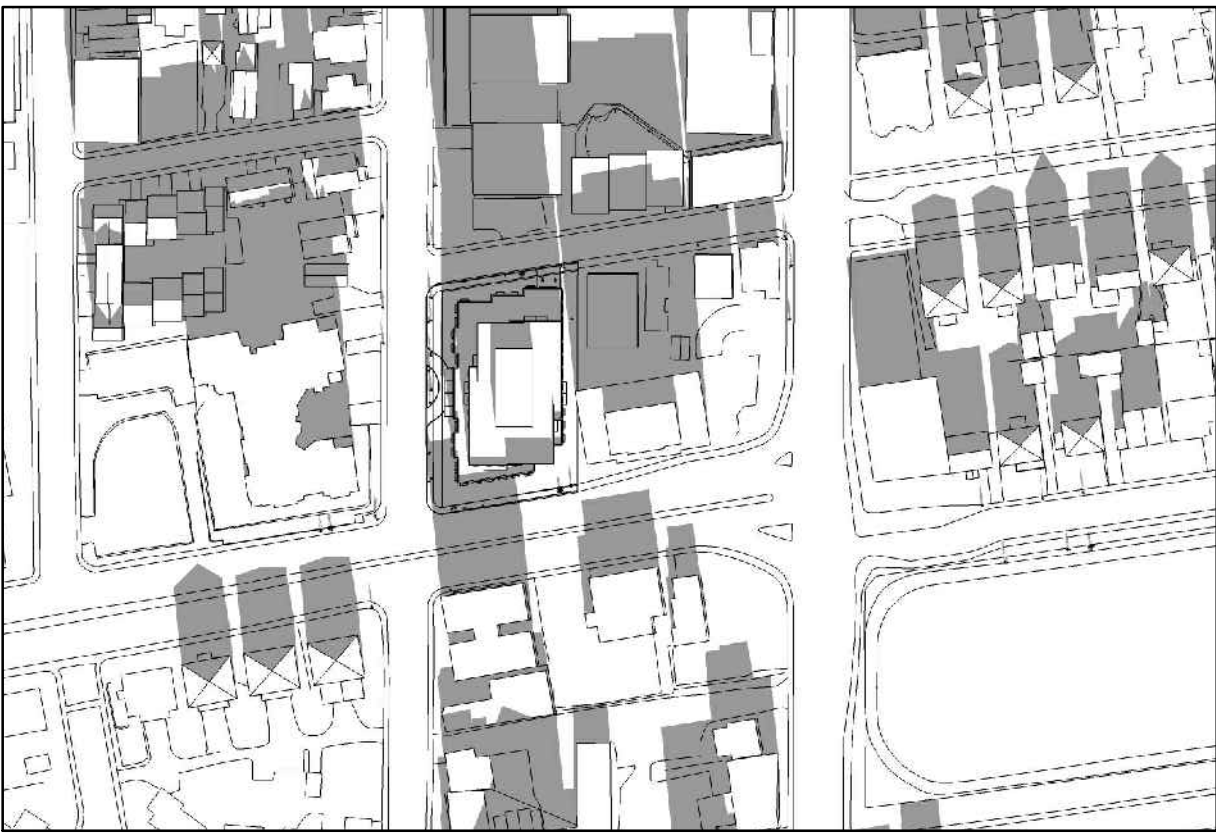

10:00 am

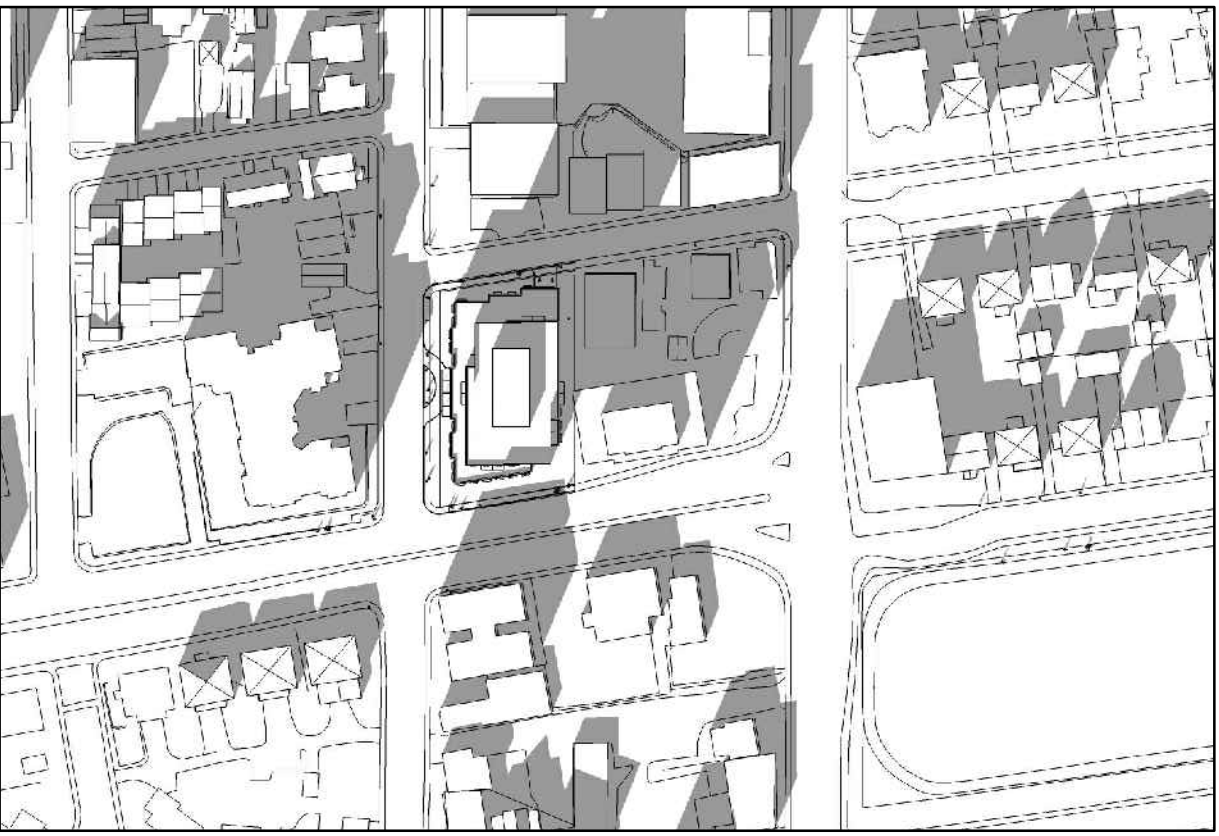

12:00 pm

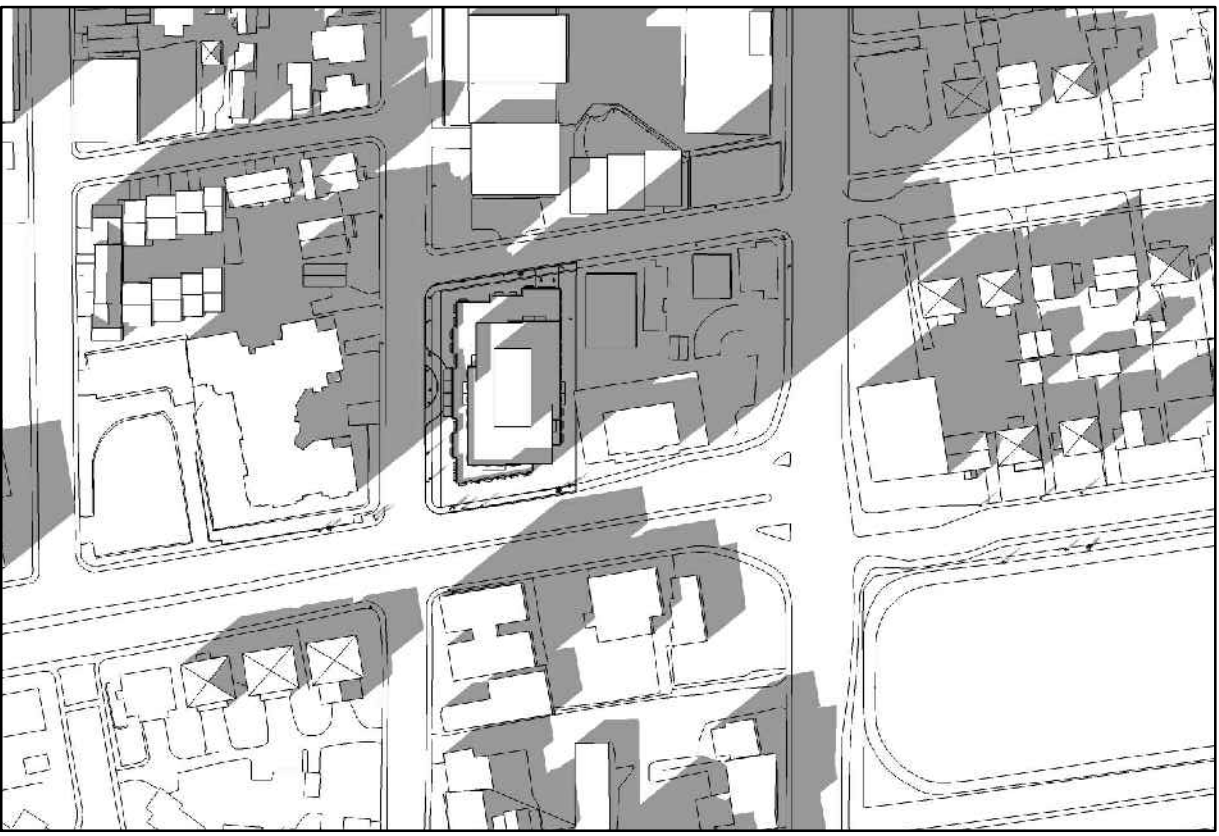

2:00 pm



4:00 pm

IT IS THE RESPONSIBILITY OF THE APPROPRIATE CONTRACTOR TO CHECK AND VERIFY ALL DIMENSIONS ON SITE AND TO REPORT ALL ERRORS AND/OR OMISSIONS TO THE ARCHITECT.  
ALL CONTRACTORS MUST COMPLY WITH ALL PERTINENT CODES AND BY-LAWS.  
THIS DRAWING MAY NOT BE USED FOR CONSTRUCTION UNTIL SIGNED BY THE ARCHITECT.  
DO NOT SCALE DRAWINGS.  
COPYRIGHT RESERVED.


NOTATION SYMBOLS:


- INDICATES DRAWING NOTES, LISTED ON EACH SHEET.
- INDICATES ASSEMBLY TYPE; REFER TO TYPICAL ASSEMBLIES SCHEDULE.
- INDICATES WINDOW TYPE; REFER TO WINDOW ELEVATIONS AND DETAILS ON A900 SERIES.
- INDICATES DOOR TYPE; REFER TO DOOR SCHEDULE AND DETAILS ON A900 SERIES.
- DETAIL NUMBER
- TITLE
- SCALE
- DETAIL REFERENCE PAGE
- DETAIL CROSS REFERENCE PAGE

GENERAL NOTES:

- REFER TO TYPICAL ASSEMBLIES SHEET FOR WALL, PARTITION, ROOF CEILING & FLOOR TYPES.
- FOR DOOR TYPES AND HARDWARE REQUIREMENTS REFER TO DOOR SCHEDULE ON A900 SERIES.
- ALL INTERIOR DIMENSIONS ARE TAKEN FROM THE FACE OF DRYWALL.
- ALL EXTERIOR DIMENSIONS ARE TAKEN FROM THE FACE OF CLADDING.
- ALL EXTERIOR WALLS ARE TO BE TYPE 'W1' UNLESS NOTED OTHERWISE.
- ALL INTERIOR PARTITIONS ARE TO BE TYPE 'P1' UNLESS NOTED OTHERWISE.

ISSUED FOR S.P.C. APPLICATION	July 27, 18
REVISED DESIGN - COMMUNITY MEETING	Sept. 21, 17
ISSUED FOR - COMMUNITY MEETING	Oct. 4, 16
O.M.B. HEARING	Mar. 4, 13
REVISED RAMP LOCATION	Mar. 4, 13
ISSUED FOR ZONING REPORT	Jan 15, 13
ISSUED FOR ZONING AMENDMENT	Mar 28, 12

ARCHITECT SEAL:  
  
SEAL DATE: STAMP DATE

NORTH ARROW:  


CLIENT:

  
TAMARACKHOMES.COM

ARCHITECT:

  
roderick lahey architect inc.  
56 beech street, ottawa, ontario K1S 3J6  
t. 613.724.9932 f. 613.724.1209 rlaarchitecture.ca

PROJECT TITLE:

275 CARLING AVENUE

CARLING @ CAMBRIDGE

OTTAWA ONTARIO

SHEET TITLE:

SHADOW STUDY

DRAWN: RV	CHECKED: R.L.A.
SCALE: NTS	SHEET No. A-10
PROJECT No. 1628	