GENERAL NOTES AND SPECIFICATIONS

- ALL MATERIALS AND CONSTRUCTION METHODS TO BE IN ACCORDANCE WITH OPS AND CITY OF OTTAWA STANDARD SPECIFICATIONS AND DRAWINGS AND OPSD SUPPLEMENT. ONTARIO PROVINCIAL STANDARDS WILL APPLY WHERE NO CITY STANDARDS ARE AVAILABLE.
- THE CONTRACTOR IS RESPONSIBLE FOR OBTAINING ALL PERMITS REQUIRED AND BEAR COST OF SAME INCLUDING WATER PERMIT AND ASSOCIATED COSTS.
- SERVICE AND UTILITY LOCATIONS ARE APPROXIMATE, CONTRACTOR TO VERIFY LOCATION AND ELEVATION OF EXISTING SERVICES AND UTILITIES PRIOR TO CONSTRUCTION. CONTRACTOR SHALL BE RESPONSIBLE FOR OBTAINING LOCATES FROM ALL UTILITY COMPANIES TO LOCATE EXISTING UTILITIES PRIOR TO EXCAVATION. THE CONTRACTOR IS RESPONSIBLE FOR PROTECTION AND REINSTATEMENT.
- ALL DISTURBED AREAS SHALL BE REINSTATED TO EQUAL OR BETTER CONDITION TO THE SATISFACTION OF THE ENGINEER & THE CITY. PAVEMENT REINSTATEMENT FOR SERVICE AND UTILITY CUTS SHALL BE IN ACCORDANCE WITH OPSD 509.010 AND OPSS 310.
- ALL WORK SHALL BE COMPLETED IN ACCORDANCE WITH THE "OCCUPATIONAL HEALTH AND SAFETY ACT AND REGULATION FOR CONSTRUCTION PROJECTS". THE GENERAL CONTRACTOR SHALL BE DEEMED TO BE THE CONSTRUCTOR AS DEFINED IN THE ACT.
- THE CONTRACTOR SHALL SUBMIT AN EROSION AND SEDIMENTATION CONTROL PLAN WHICH WILL IMPLEMENT BEST MANAGEMENT PRACTICES TO PROVIDE PROTECTION FOR RECEIVING STORM SEWERS OR DRAINAGE DURING CONSTRUCTION ACTIVITIES. THIS PLAN SHALL INCLUDE BUT NOT LIMITED TO FILTER CLOTH ON CATCH BASINS, STRAW BALE CHECK DAMS AND SEDIMENT CONTROLS AROUND ALL DISTURBED AREAS. DEWATERING SHALL BE PUMPED INTO SEDIMENT TRAPS.
- SITE PLAN PREPARED BY:
- B. TOPOGRAPHIC SURVEY SUPPLIED BY STANTEC GEOMATICS LIMITED, PART OF LOT 19, CONCESSION 2 (RIDEAU FRONT), GEOGRAPHIC TOWNSHIP OF NEPEAN, CITY OF OTTAWA.
- LANDSCAPE ARCHITECTURE PLAN PREPARED BY OTHERS . REFER TO ORIGINAL LANDSCAPE ARCHITECTURE PLAN FOR ALL LANDSCAPING

- FEATURES (ie. TREES, WALKWAYS, PARK DETAILS, NOISE BARRIERS, FENCES etc.)
- 10. GEOTECHNICAL INVESTIGATION PG3597-1 PREPARED BY PATERSON GROUP DATED OCTOBER 15, 2015. GEOTECHNICAL INFORMATION PRESENTED ON THESE DRAWINGS MAY BE INTERPOLATED FROM THE ORIGINAL REPORT. REFER TO ORIGINAL GEOTECHNICAL REPORT FOR ADDITIONAL DETAILS AND TO VERIFY ASSUMPTIONS MADE HEREIN.
- 11. STREET LIGHTING TO CITY OF OTTAWA STANDARDS.
- 12. ALL DIMENSIONS ARE IN METRES UNLESS OTHERWISE STATED. DIMENSIONS SHALL BE CHECKED AND VERIFIED IN THE FIELD BY THE CONTRACTOR PRIOR TO THE START OF CONSTRUCTION. ANY DISCREPANCIES TO BE REPORTED IMMEDIATELY TO ENGINEER.
- 13. THERE WILL BE NO SUBSTITUTION OF MATERIALS UNLESS PRIOR WRITTEN APPROVAL BY THE CONTRACT ADMINISTRATOR AND DIRECTOR OF ENGINEERING HAS BEEN OBTAINED.
- 14. HERITAGE OPERATIONS UNIT OF THE ONTARIO MINISTRY OF CULTURE TO BE NOTIFIED IF DEEPLY BURRIED ARCHEOLOGICAL REMAINS ARE FOUND ON THE PROPERTY DURING CONSTRUCTION ACTIVITIES.

WATER SUPPLY SERVICING


- 1. THE CONTRACTOR SHALL CONSTRUCT WATERMAIN, WATER SERVICES, CONNECTIONS & APPURTENANCES AS PER CITY OF OTTAWA SPECIFICATIONS & SHALL CO-ORDINATE AND PAY ALL RELATED COSTS INCLUDING THE COST OF CONNECTION, INSPECTION & DISINFECTION BY CITY PERSONNEL.
- WATERMAIN PIPE MATERIAL SHALL BE PVC CL.150 DR18. DEFLECTION OF WATERMAIN PIPE IS NOT TO EXCEED 1/2 OF THAT SPECIFIED BY THE MANUFACTURER. PVC WATERMAINS TO BE BE INSTALLED WITH TRACER WIRE IN ACCORDANCE WITH CITY OF OTTAWA STANDARD W36.
- WATER SERVICES ARE TO BE TYPE K SOFT COPPER AS PER CITY OF OTTAWA STANDARD W26 (UNLESS OTHERWISE NOTED). WATER SERVICE TO EXTEND 1.0M BEYOND PROPERTY LINE. STAND POST TO BE INSTALLED AT PROPERTY LINE.
- 4. FIRE HYDRANTS TO BE INSTALLED AS PER CITY OF OTTAWA STANDARDS


W18 AND W19.

- COVER MATERIAL TO BE SPECIFIED BY PROJECT GEOTECHNICAL CONSULTANT
- ACHIEVED (AS PER CITY OF OTTAWA W22 & W23)
- 8. CATHODIC PROTECTION TO BE SUPPLIED ON METALIC FITTINGS AS PER CITY OF OTTAWA W40 AND W42.
- W25.3 AND W25.4
- STANDARD W22.
- PER CITY OF OTTAWA STANDARD W25 AND W25.2.
- PLUMBING CODE.

STORM AND SANITARY SEWERS

- CLASS 100D AS PER OPSD 807.010.
- CLASS 100-D AS PER OPSD 807.010

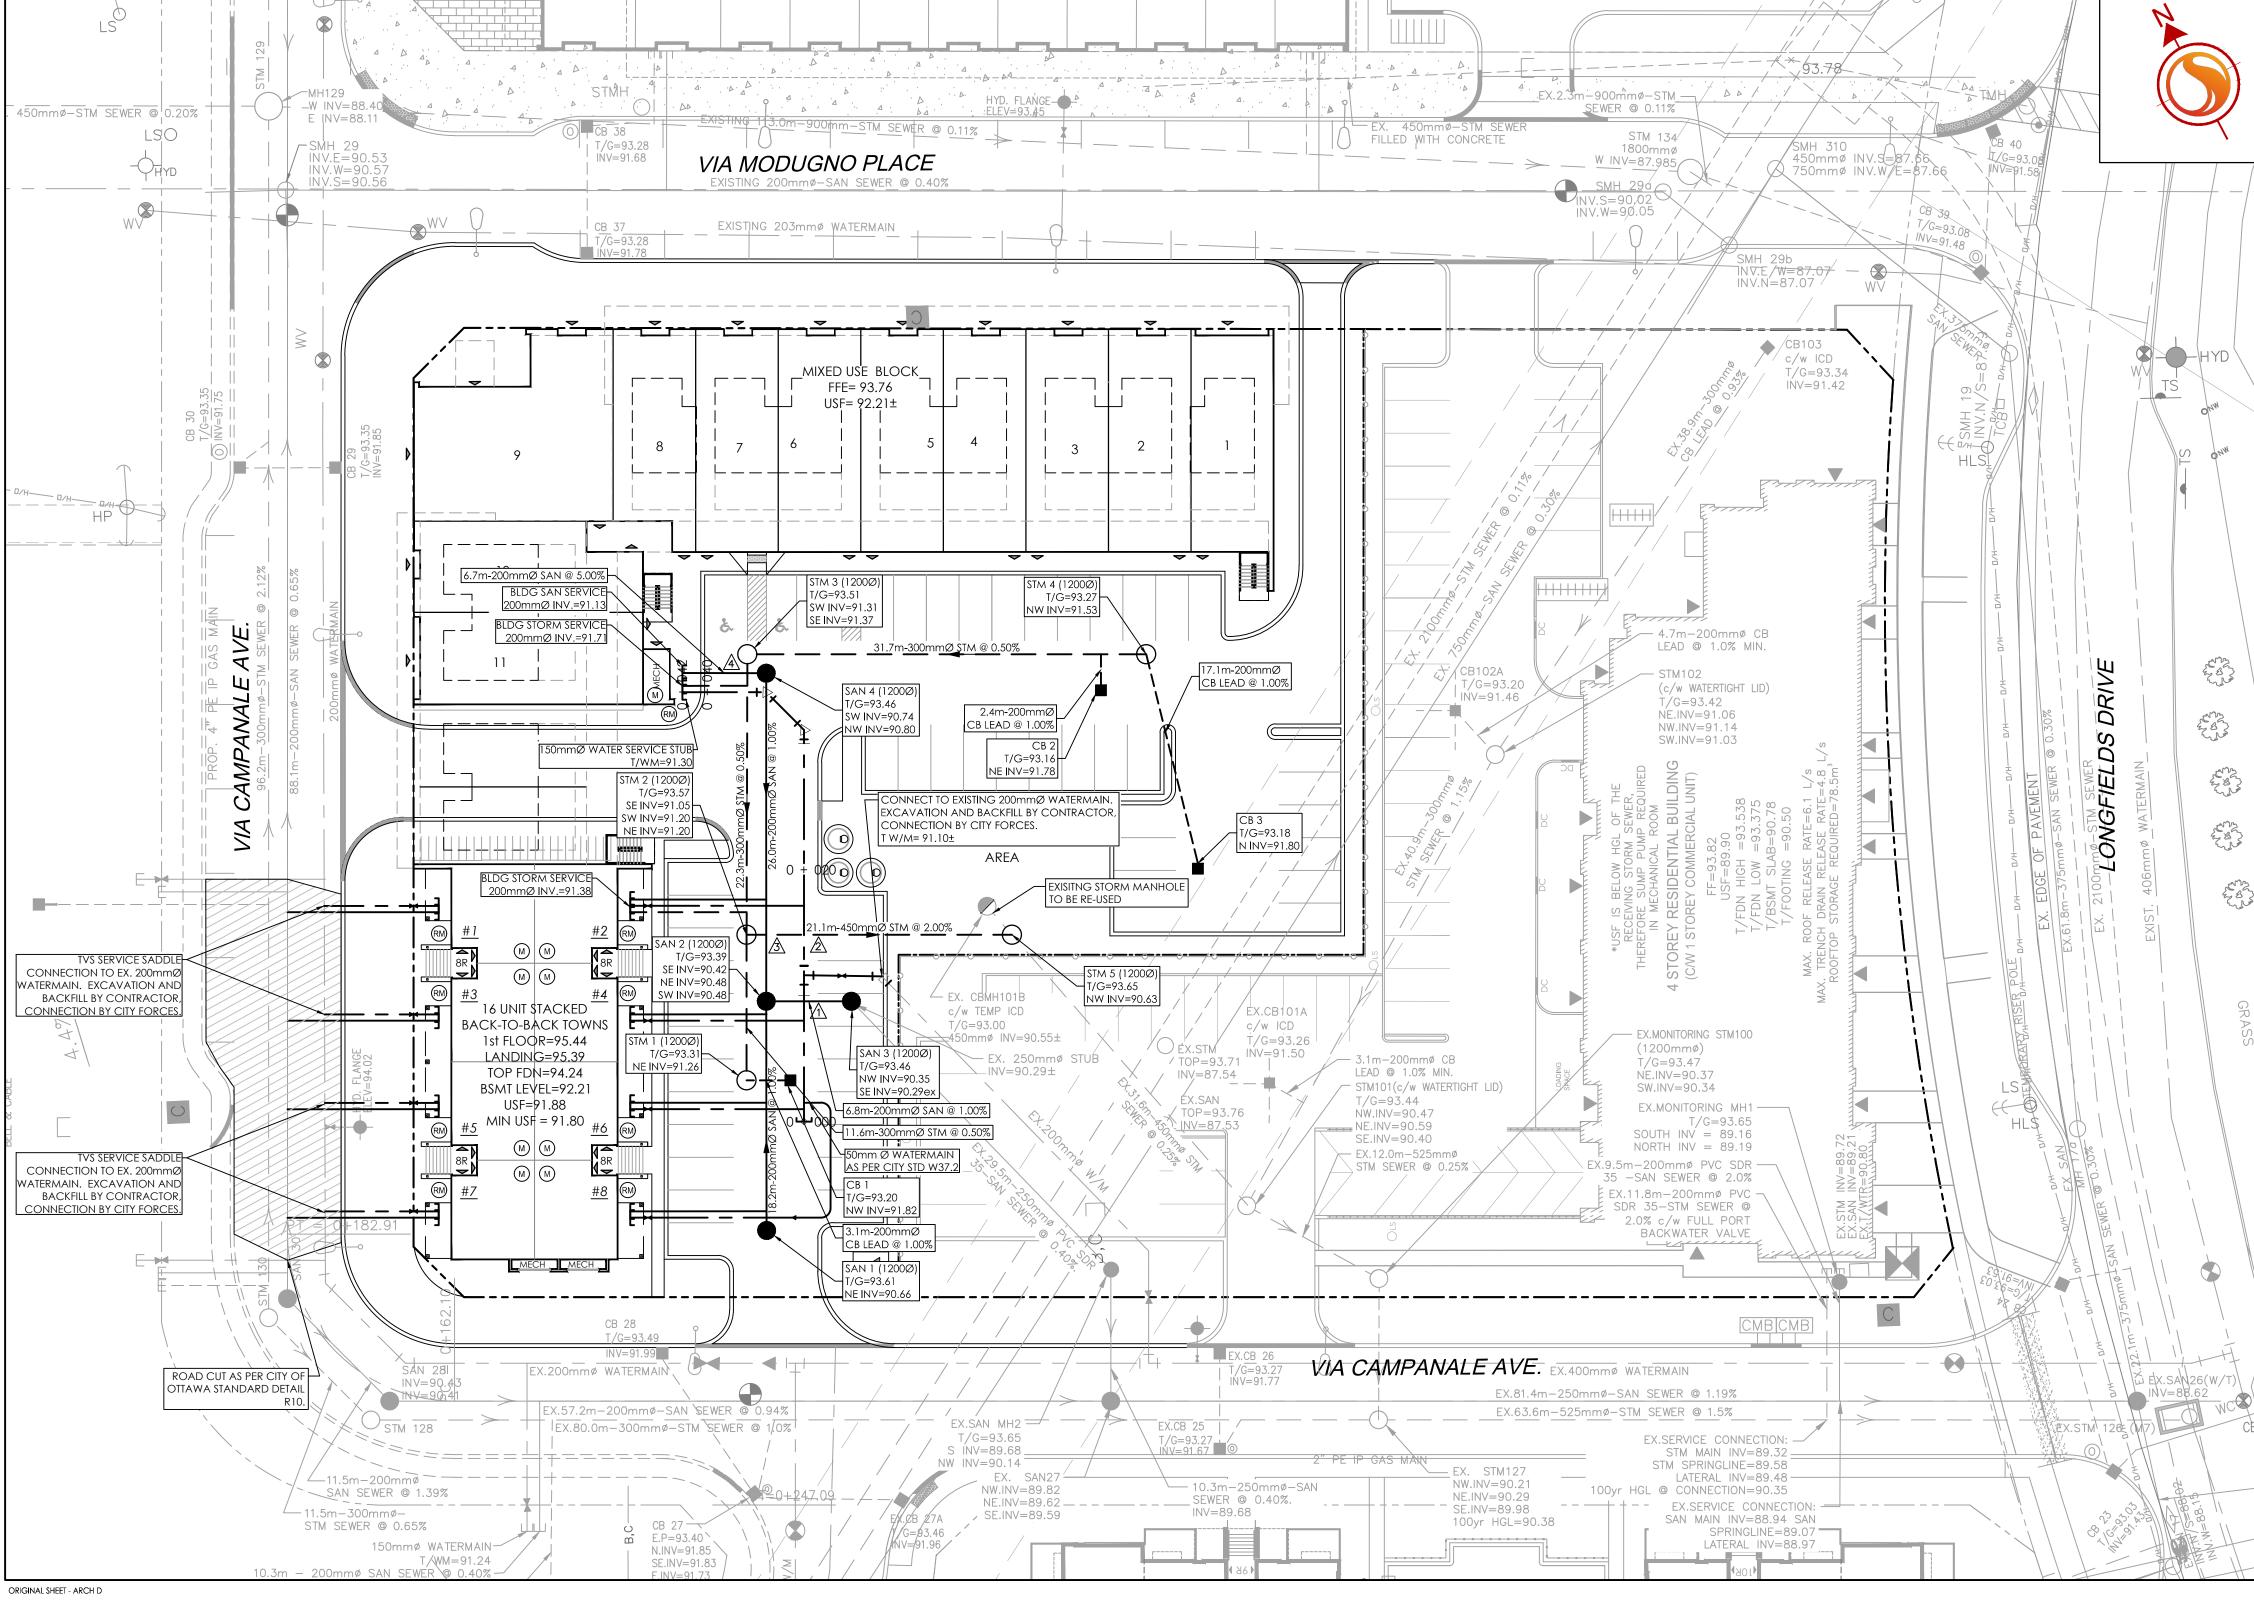

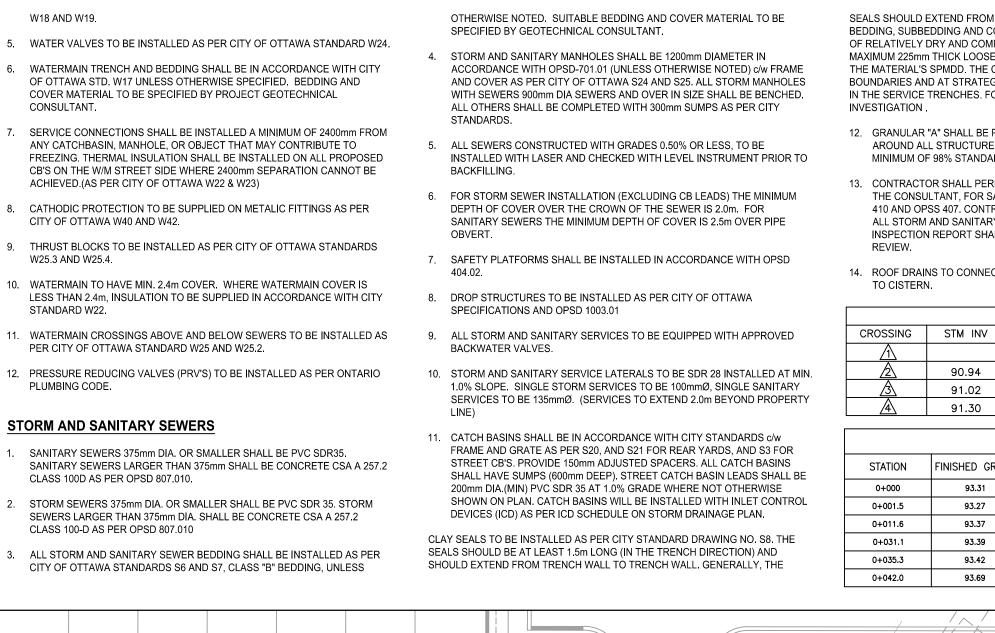


SEALS SHOULD EXTEND FROM THE FROST LINE AND FULLY PENETRATE THE BEDDING SUBBEDDING AND COVER MATERIAL. THE BARRIERS SHOULD CONSIST OF RELATIVELY DRY AND COMPACTABLE BROWN SILTY CLAY PLACED IN MAXIMUM 225mm THICK LOOSE LAYERS COMPACTED TO A MINIMUM OF 95% OF THE MATERIAL'S SPMDD. THE CLAY SEALS SHOULD BE PLACED AT THE SITE BOUNDARIES AND AT STRATEGIC LOCATIONS AT NO MORE THAN 60m INTERVALS IN THE SERVICE TRENCHES. FOR DETAILS REFER TO GEOTECHNICAL

- 12. GRANULAR "A" SHALL BE PLACED TO A MINIMUM THICKNESS OF 300 mm AROUND ALL STRUCTURES WITHIN PAVEMENT AREA AND COMPACTED TO A MINIMUM OF 98% STANDARD PROCTOR DENSITY.
- 13. CONTRACTOR SHALL PERFORM LEAKAGE TESTING, IN THE PRESENCE OF THE CONSULTANT, FOR SANITARY SEWERS IN ACCORDANCE WITH OPSS 410 AND OPSS 407. CONTRACTOR SHALL PERFORM VIDEO INSPECTION OF ALL STORM AND SANITARY SEWERS. A COPY OF THE VIDEO AND INSPECTION REPORT SHALL BE SUBMITTED TO THE CONSULTANT FOR
- 14. ROOF DRAINS TO CONNECT TO BUILDING INTERNAL PLUMBING AND DRAIN

SEWER AND WATERMAIN CROSSING TABLE						
CROSSING	STM INV	STM OBV	SAN INV	SAN OBV	WTR TOP	WTR BTM
			90.38	90.58	90.98	90.83
Â	90.94	91.39			90.06	90.91
A	91.02	91.47	90.53	90.73		
A	91.30	91.60	90.81	91.09		

150mmØ WATERMAIN					
STATION	FINISHED GRADE	TOP OF W/M	ITEM		
0+000	93.31	90.91	150mmø CAP AND THRUST BLOCK		
0+001.5	93.27	90.87 150mmø x 50mmø TEE WATERMAIN			
0+011.6	93.37	90.97	150mmø x 200mmø TEE WATERMAIN		
0+031.1	93.39	90.99	22.5" HORIZONTAL BEND		
0+035.3	93.42	91.02	22.5" HORIZONTAL BEND		
0+042.0	93.69	91.29	150mmø CAP AND THRUST BLOCK		

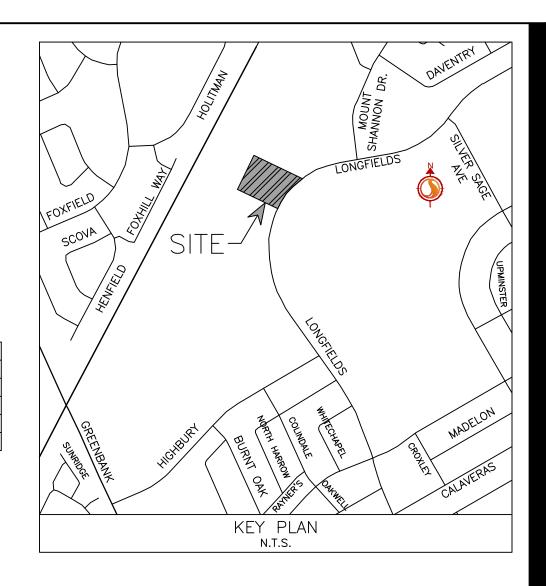



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Legend

	M
	RM
	M
	
DC	
	DC
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PROPOSED WATERMAIN
PROPOSED VALVE AND VALVE BOX
PROPOSED WATER METER
PROPOSED REMOTE WATER METER
PROPOSED SANITARY SEWER
PROPOSED STORM SEWER
PROPOSED CATCHBASIN
EXISTING WATERMAIN
EXISTING VALVE AND VALVE BOX
EXISTING VALVE CHAMBER
EXISTING REDUCER
EXISTING FIRE HYDRANT
EXISTING SANITARY SEWER
EXISTING STORM SEWER
EXISTING CATCHBASIN MANHOLE
EXISTING CATCHBASIN
PROPOSED DEPRESSED CURB LOCATIONS
PROPOSED TRANSFORMER LOCATION

16 UNIT TERRACE HOMES SERVICES
200mm STORM SERVICE PVC SDR 28 @ 1% MIN
150mm SANITARY SERVICE PVC SDR 28 @ 1% MIN
19mm TYPE K SOFT COPPER WATER SERVICE C/W CURB STOP AND SERVICE POST

Notes

MECHANICAL CONSULTANT TO VERIFY SANITARY, STORM AND WATER SERVICE SIZES FOR EACH STACK OF UNITS. ROOF LEADERS ARE TO BE DIRECTED TO INTERNAL PARKING LOTS

SCHEDULE OF INLET CONTROL DEVICES						
	STRUCTURE ID	DRAINAGE AREA ID	ICD TYPE	ICD INVERT (m)	100 YEAR HEAD (m)	100 YEAR FLOW (L/s)
Γ	CB 1	STM-1	IPEX TEMPEST LMF 70	91.82	1.68	5.6
	CB 2	STM-2	IPEX HF (75mm ORIFICE)	91.78	1.60	15.1
	CB 3	STM-3	IPEX TEMPEST LMF 60	91.80	1.68	4.2

1 ISSUED FOR SPA		AJ	DT	19.09.12
Revision		By	Appd.	YY.MM.DD
File Name: 160401500 BLK 15 DB.DWG	MJS	SG	AJ	19.07.25
	Dwn.	Chkd.	Dsgn.	YY.MM.DD

Permit-Seal

Client/Project CAMPANALE HOMES LONGFIELDS STATION BLOCK 14

OTTAWA, ON, CANADA

SITE SERVICING PLAN

Title

Project No. Scale 1:300 160401500 Sheet Drawing No. Revision SSP-1 2 of 6