



SAN STRUCTURE TABLE				
NAME	RIM ELEV.	INVERT IN	INVERT OUT	DESCRIPTION
MH2A	75.79	S673.520	N73.278	STRUC. OPSD 701.011 COVER CITY 524 FRAME CITY 525
MH2B	75.23	S73.111	N71.194	STRUC. OPSD 701.011 COVER CITY 524 FRAME CITY 525 CW EXTERNAL DUCT STRUCTURE PER OPSD 1003.010
MH2C	71.16	S68.710	NW68.650	STRUC. OPSD 701.011 COVER CITY 524 FRAME CITY 525
MH2D	70.11	S67.200	SW66.440	STRUC. OPSD 701.011 COVER CITY 524 FRAME CITY 525 CW EXTERNAL DUCT STRUCTURE PER OPSD 1003.010
MH2E	69.45	NE65.500	NW65.080	STRUC. OPSD 701.011 COVER CITY 524 FRAME CITY 525

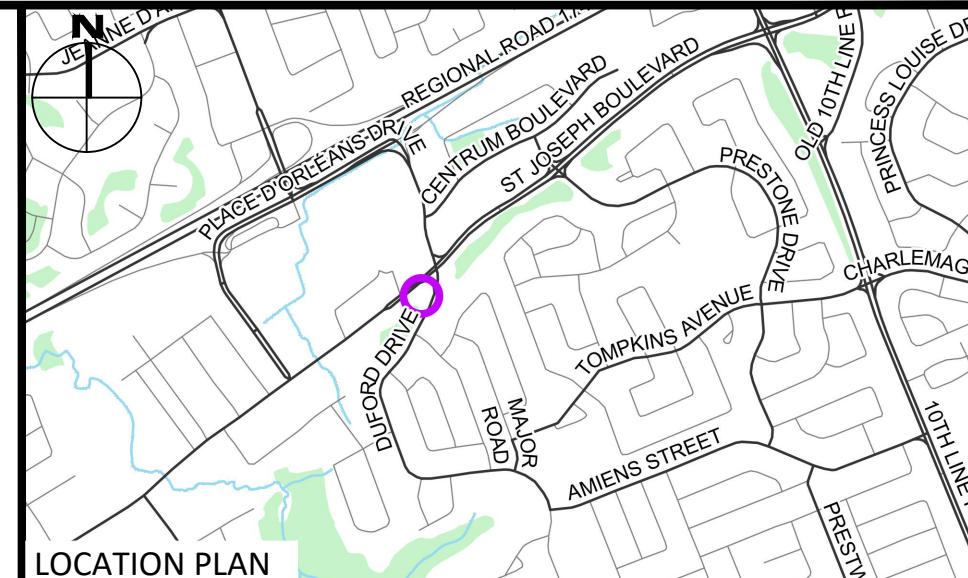

LEGEND		
UC	BARRIER CURB & CURB DEPRESSION	
PROPOSED CONCRETE PAVERS	SLOPING AT 3:1 UNLESS SPECIFIED	
MHR	STORM MANHOLE	
CB	CATCHBASIN, CURB INLET OR DITCH INLET	
MHA	SANITARY MANHOLE	
PROPERTY LINE	PRE AND POST-DEVELOPMENT DRAINAGE DIRECTIONS	
EX. WATER VALVE/CHAMBER	HEAVY DUTY SILT FENCE BARRIER PER OPSD 219.130	
PROP. VALVE PER CITY W24	BUILDING ENTRANCE	
FIRE HYDRANT	PROPOSED GRASS	
PROPOSED WALL	CENTRELINE OF SWALE	
PROPOSED SIAMASE CONNECTION	PROPOSED ROADCUT AND REINSTATEMENT PER CITY R10	
PROPOSED WATER METER AND REMOTE METER	CB SILT SACK PER C101 DETAIL	
PROP AND EX. REDUCER	SERVICE/SEWER CROSSING	
L/G HYDRO DUCT PER ELEC.	L	EX. UG STREET LIGHT
EX. STM SEWER	TF	EX. TRAFFIC LINE
EX. SAN SEWER	W	EX. WATERMAIN
	GAS	EX. GAS
	OHW	EX. OHW
	BELL	EX. BELL
	ROG	EX. ROGERS

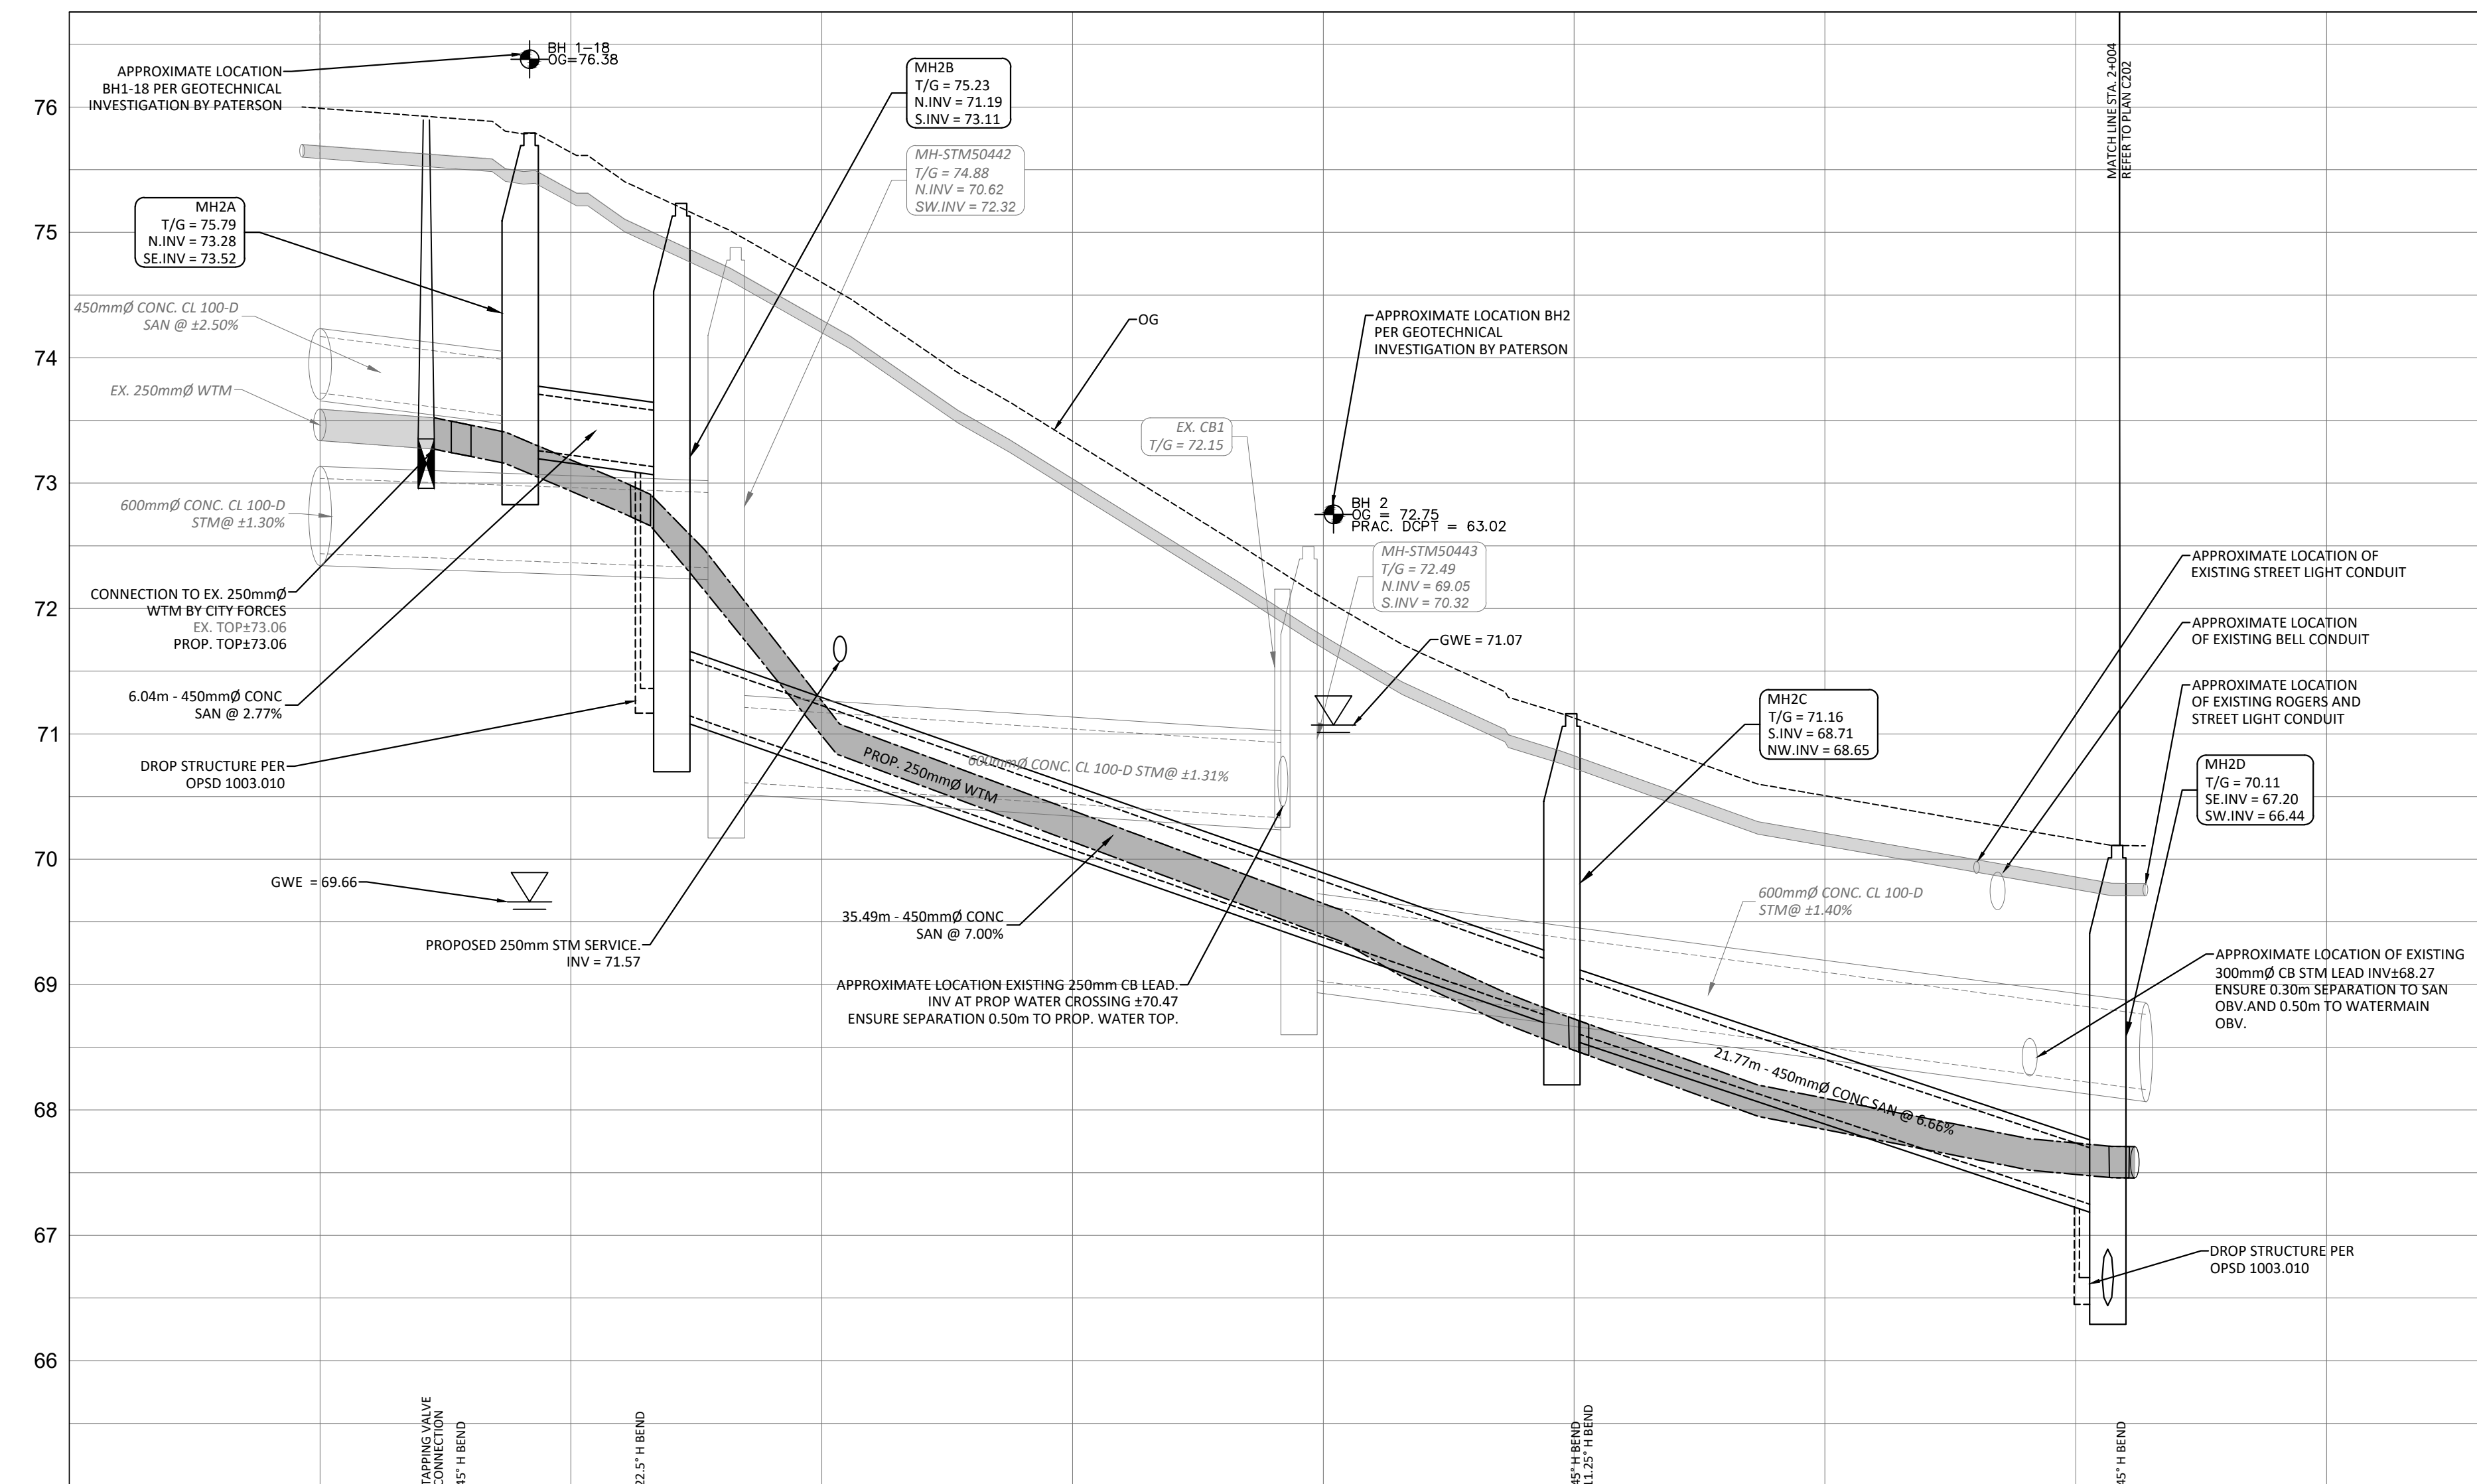

ELEVATIONS PROPOSED		NOTE: CONTRACTOR IS TO PREPARE A SEWER FLOW MANAGEMENT PLAN TO THE SATISFACTION OF THE CITY PRIOR TO CONSTRUCTION.	
TOP OF WATERMAIN	SANITARY SEWER	STATION	STATION
73.53	73.86	1+000	1+000
73.48	73.53	1+004	1+004
73.48	73.53	1+006	1+006
73.38	73.53	1+008	1+008
72.95	73.11	1+013	1+013
71.05	71.19	1+020	1+020
69.75	71.05	1+021	1+021
68.75	72.08	1+038	1+038
68.70	72.08	1+040	1+040
68.70	72.08	1+050	1+050
68.70	72.08	1+050	1+050
67.71	70.50	1+059	1+059
67.71	70.50	1+062	1+062
67.71	70.50	1+072	1+072
67.71	70.50	1+080	1+080

SUBJECT TO APPROVAL		
2	ISSUED FOR REVIEW	JUL 31, 2024
1	ISSUED FOR SITE PLAN CONTROL	MAR 07, 2024
No.	Revisions	Date

Check and verify all dimensions before proceeding with the work. Do not scale drawings.

SCALE 1 : 200

egis 115 Walgreen Road, R.R.3
Carp, ON K0A 1L0
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Fax: 613-836-3742
www.egis-group.com

C. A. MACLEOD
LICENSED PROFESSIONAL ENGINEER
100159100
JULY 31/2024
PROVINCE OF ONTARIO

Client: **THEBERGE DEVELOPMENTS LTD**
1600 LAPERRIERE AVE
OTTAWA, ON K1Z 8P5

Project: **3030 ST. JOSEPH BOULEVARD**
OTTAWA ON

Drawing Title: **PLAN & PROFILE STA. 1+000 TO 1+063**

Scale: 1:200 Project Number: CCO-24-0142

Drawn By: RRR

Checked By: AM

Designed By: RRR

Drawing Number: **C201**

FILENAME: I:\Information\2024\CCO-24-0142\Theberge - 2024\9 Joseph Blvd\12 - Drawing\CCO-24-0142 - PRESENTATION.dwg
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 LAST SAVER: B. J. ROBERTSON
 LAST PLOTTED: Wednesday, July 31, 2024 10:51:51 AM
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D07-12-23-0090