



KEY PLAN  
N.T.S.

LEGEND

- 200.00 0.5% PROPOSED ITEMS
- 200.00 0.5% EXISTING ITEMS
- LIMIT OF PROPERTY LINE
- LIMIT OF UNDERGROUND STRUCTURE
- × [200.00] PROP ELEVATION TO MATCH EXISTING
- EMERGENCY OVERLAND FLOW ROUTE
- MH / CB/MH / DCB/MH / OGS
- CB / DCB / AD / TD
- ⊕ HYDRANT / SIAMESE / VALVE BOX

BENCHMARK: ELEVATIONS ARE GEODETIC, IN METRES, AND DERIVED FROM THE CAN-NET VRS NETWORK MONUMENT: OTTAWA  
ELEVATION=95.230  
BEARINGS ARE GRID, DERIVED FROM THE CAN-NET VRS NETWORK OBSERVATIONS ON NCC HORIZ CONTROL MONUMENTS 19773035 & 19680191, CENTRAL MERIDIAN, 76°30' W LONGITUDE MTM ZONE 9

SITE PLAN: KPMG, PERKINS & WILL

SURVEY: STANTEC GEOMATICS LTD., 220324

1	ISSUED FOR OPA / ZBA / SPA	220414	C.B.
NO.	ISSUE	DATE	BY

**DRAWING NOTES NOT FOR CONSTRUCTION**

- THIS DRAWING IS THE EXCLUSIVE PROPERTY OF THE MUNICIPAL INFRASTRUCTURE GROUP LTD (TMIG). THE REPRODUCTION OF ANY PART WITHOUT PRIOR WRITTEN CONSENT FROM TMIG IS STRICTLY PROHIBITED.
- THIS DRAWING IS TO BE READ AND UNDERSTOOD IN CONJUNCTION WITH ALL OTHER DRAWINGS AND DOCUMENTS APPLICABLE TO THIS PROJECT.
- THIS DRAWING IS NOT TO BE ISSUED FOR CONSTRUCTION UNTIL ALL REQUIRED PERMITS HAVE BEEN ISSUED.
- THE CONTRACTOR SHALL VERIFY ALL DIMENSIONS, ELEVATIONS, INVERTS AND DATA ON SITE AND REPORT ANY DISCREPANCIES OR OMISSIONS TO TMIG 48 HOURS PRIOR TO ANY CONSTRUCTION.

ABBREVIATIONS		HOPE = HIGH DENSITY POLYETHYLENE	
GENERAL:	TW = TOP OF WALL	BW = BOTTOM OF WALL	CONC = CONCRETE
PROP = PROPOSED	EX = EXISTING	SERVICES:	STM = STORM
ELEVATIONS:	TC = TOP OF CURB	BC = BOTTOM OF CURB	WAT = WATER
			PVC = POLYVINYL CHLORIDE
			AD = AREA DRAIN
			TD = TRENCH DRAIN




GRADING PLAN

LEBRETON LIBRARY PARCEL

DREAM

SCALE: 1:250	PROJECT # 10399
DATE: APRIL 2022	DRAWING #
DRAWN BY: C.B.	G1
DESIGNED BY: C.B.	
CHECKED BY: B.D.	

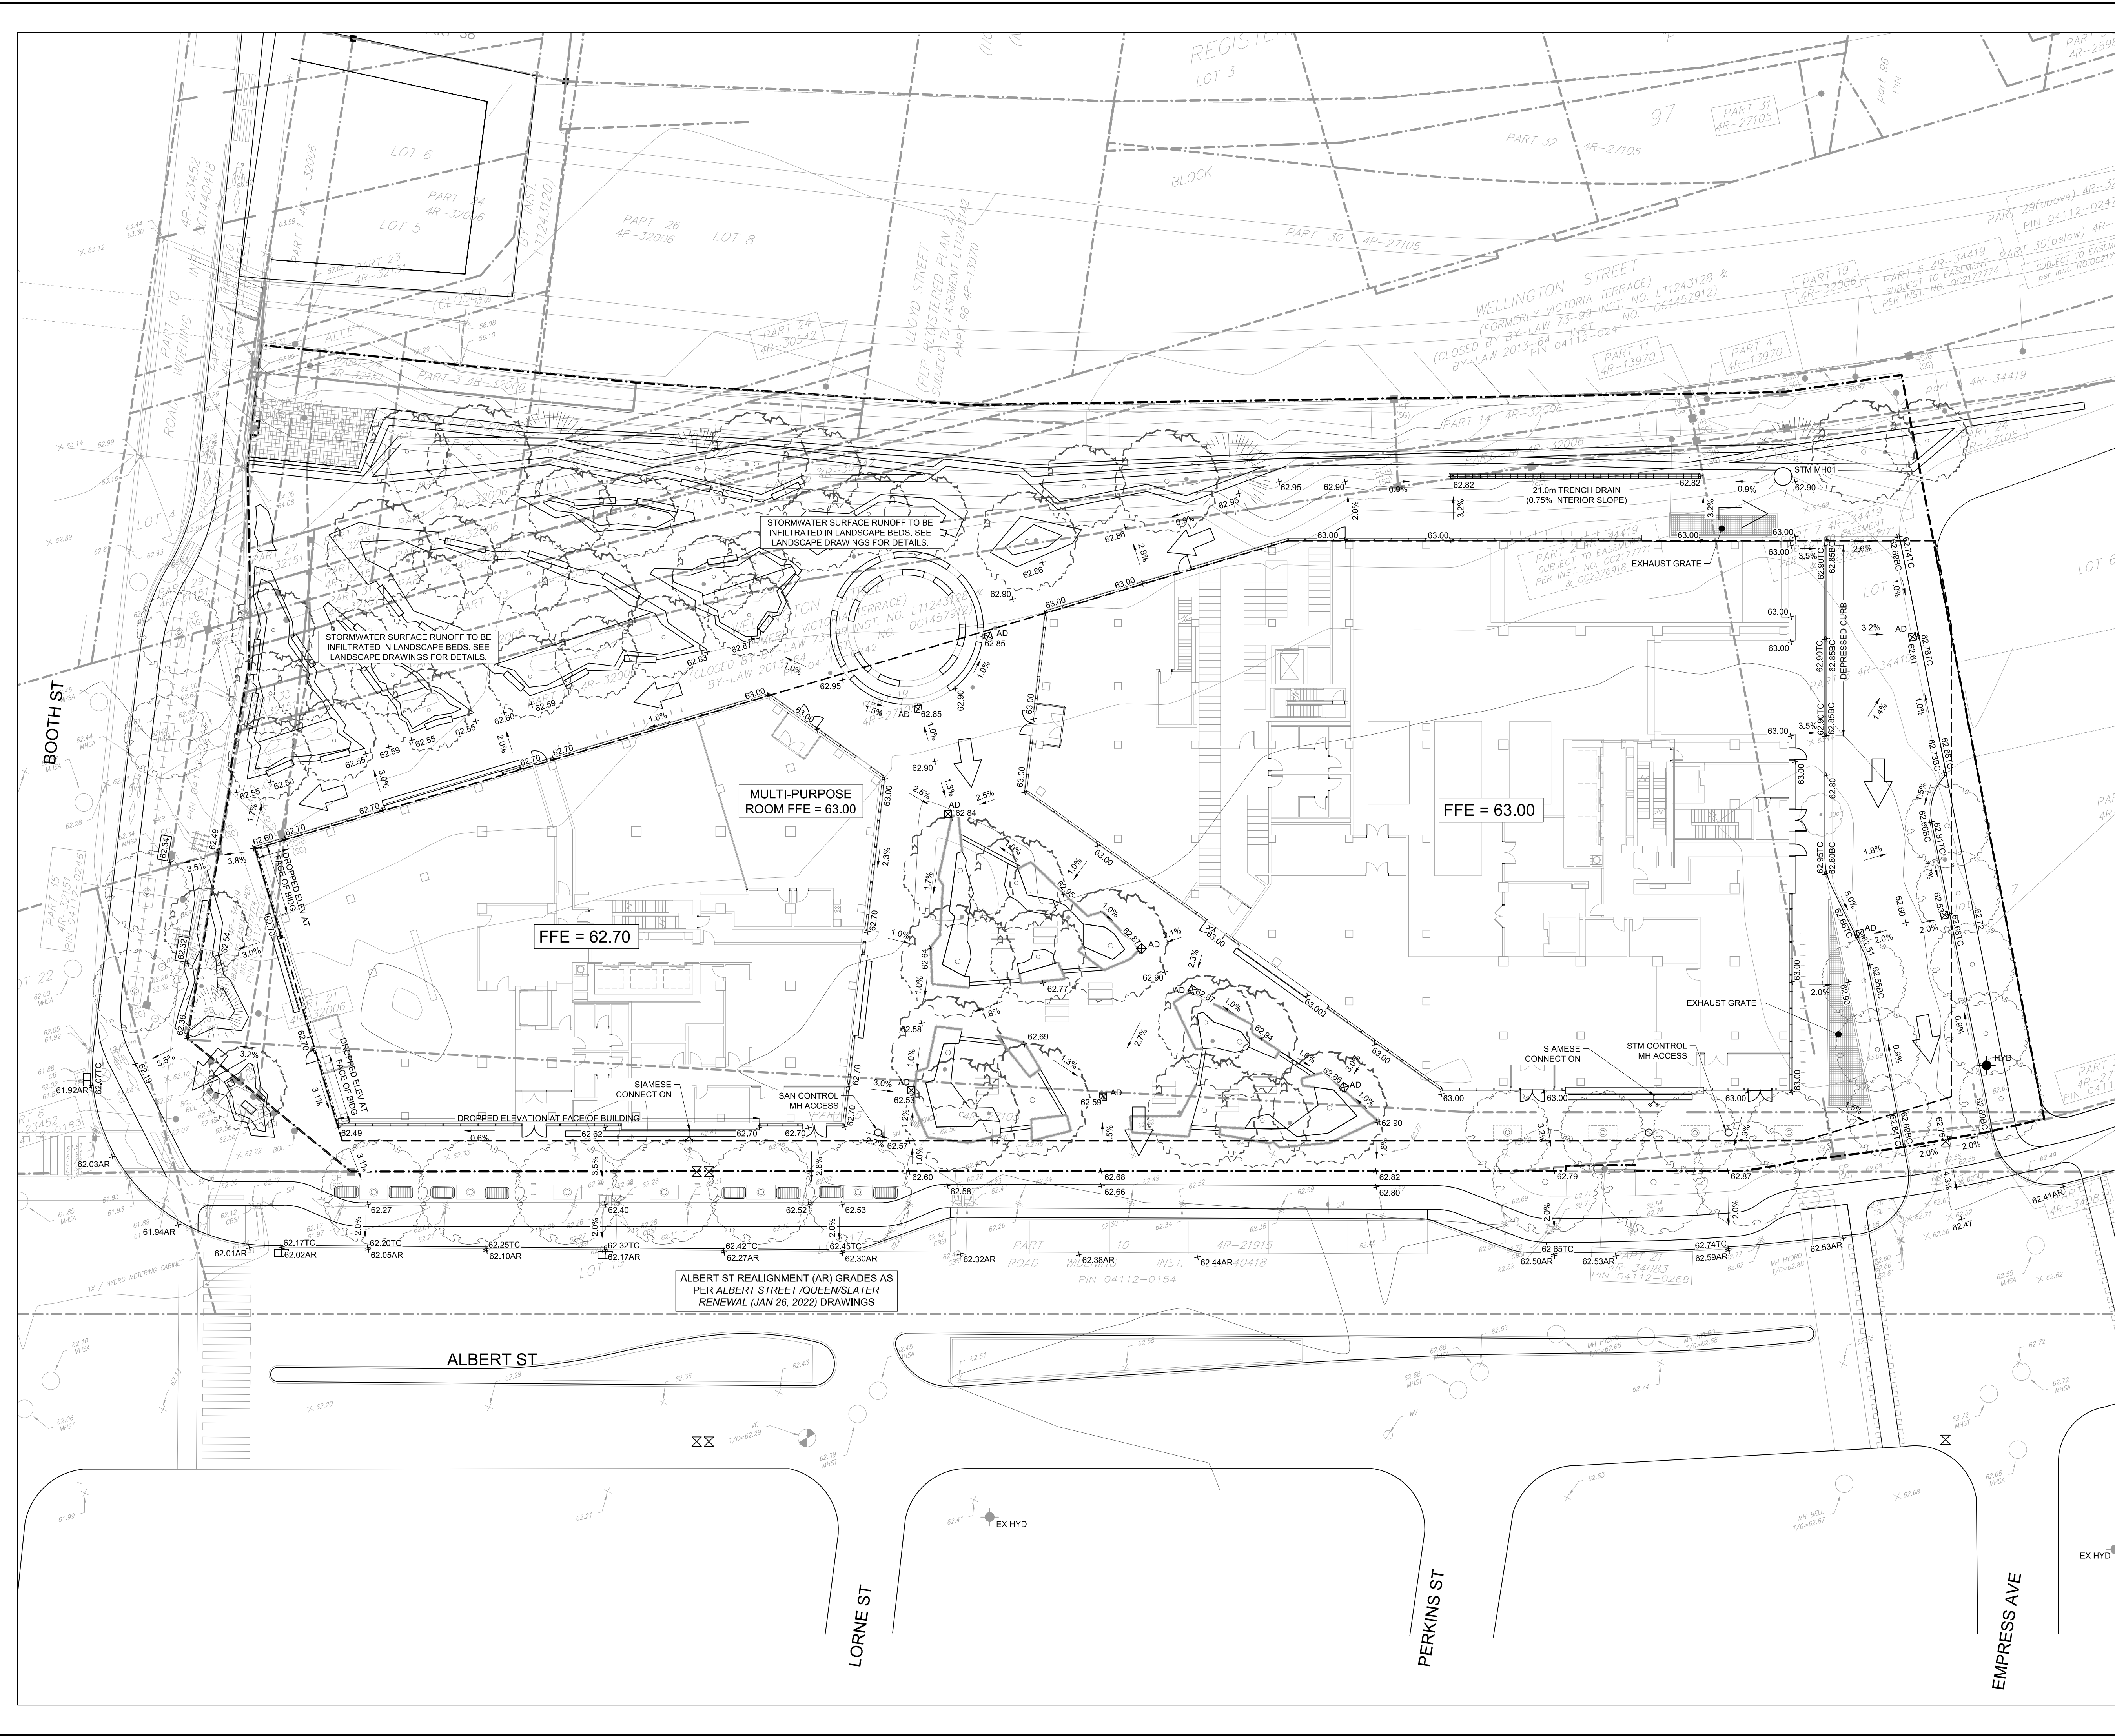

File: G:\Projects\2022\10399 - Dream - Lebreton Library Parcel\Civil\Drawings\1. Design\DWG - Layout\_G1 Date: Apr 22, 2022 - 11:06am. Edit By: cadib.beaudoin