



|                    | LEGEND   Trees and shrubs Trees and ornamental grasses Output <p< th=""><th>Revision       Appr.       Date         1       SITE PLAN CONTROL       E.P.       06/06/2017         2       SITE PLAN CONTROL       S.G.       26/09/2017         -       -       &lt;</th></p<> | Revision       Appr.       Date         1       SITE PLAN CONTROL       E.P.       06/06/2017         2       SITE PLAN CONTROL       S.G.       26/09/2017         -       -       <   |
|--------------------|--|---|
|                    | PLANTING LIST - SALVATION ARMY BOOTH CENTRE         Key       Qty       Latin name       Caliper       qty/m²         EVERGREEN TREES         PGL       3       Picea glauca       50mm       see plan         DECIDUOUS TREES       50mm       see plan         GTB       6       Gleditsia triacanthos 'Sunburst'       50mm       see plan         ARU       8       Acer rubrum       50mm       see plan         ARU       8       Acer rubrum       50mm       see plan         AGI       6       Acer Ginnala       50mm       see plan         AGI       6       Acer Ginnala       50mm       see plan         TON       17       Taxus cuspidata 'Nana'       50mm       see plan         EAC       30       Euonymus alatus 'Compacta'       30cm       see plan         POG       34       Physocarpus opul. Dart's Gold'       30cm       see plan         RAL       46       Ribes alpinum       30cm       see plan         RAL       46       Ribes alpinum       30cm       see plan         FERNS       pot 1 litre       3,2       2       Calamagrostis brachytricha       pot 1 litre       3,2      <  | <ol> <li>Note :</li> <li>It is the responsibility of the appropriate contractor or official to report any errors, omissions or discrepancies on this plan with actual site conditions to the Landscape Architect before proceeding with construction.</li> <li>The Contractor must not cut down any existing vegetation without the approval of the Project Director.</li> <li>Implantation of the works on site must be approved by the Project Director.</li> <li>The Contractor must use the Cad file for implantation of all work. The contractor must verify the amounts specified in the schedule and notify the landscape architect of any errors, omissions or contradictions before the close of the bid.</li> </ol>   |
|                    |  | <ol> <li>Existing grades indicated on the plan come from the survey provided by the owner.</li> <li>The contractor is to notify all utility companies and authorities prior to any excavation and ascertain locations of underground services.</li> <li>The contractor is to reinstate all areas and items damaged as a result of construction activity.</li> <li>The contractor is to comply with all pertinent codes and by-laws.</li> <li>The contractor is to maintain a positive surface run-off throughout the entire construction period.</li> <li>The contractor is to stake the proposed location of all plant material in conjunction with the Landscape Architect prior to excavation.</li> <li>All trees within 1m of underground utility trenches are to be excavated by hand.</li> <li>Remove all protective wrapping from tree trunks after installation.</li> <li>Staking of trees shall only be performed if necessary.</li> <li>Ensure that mulch is pulled back a min. distance of 75mm from base of tree trunks.</li> </ol> |
|                    |  | APPROVED REFUSED   THIS DAY OF   DOUGLAS JAMES, MCIP, RPP   AMANAGER, DEVELOPMENT REVIEW CENTRAL   PLANNING, INFRASTRUCTURE & ECONOMIC   DEVELOPMENT DEPARTMENT, CITY OF OTTAWA <b>ORDSJEE PACASAGES</b> A Mont-Royal Quest, Suite 801 Mortéal, QC, H2T 2S2 314 849 7700 Professional seal  |
| TRES MINIMUM CLEAR | ANCE BETWEEN THE WATERDRAIN  | Project name<br>333 MONTREAL ROAD<br>Ottawa, Ontario<br>Drawing title<br>PLANTING PLAN<br>Scale 1:250<br>Drawn by:<br>B.DALLAS<br>Designed by:<br>B.DALLAS / S.GALLANT<br>Date :<br>MAY 2017  |

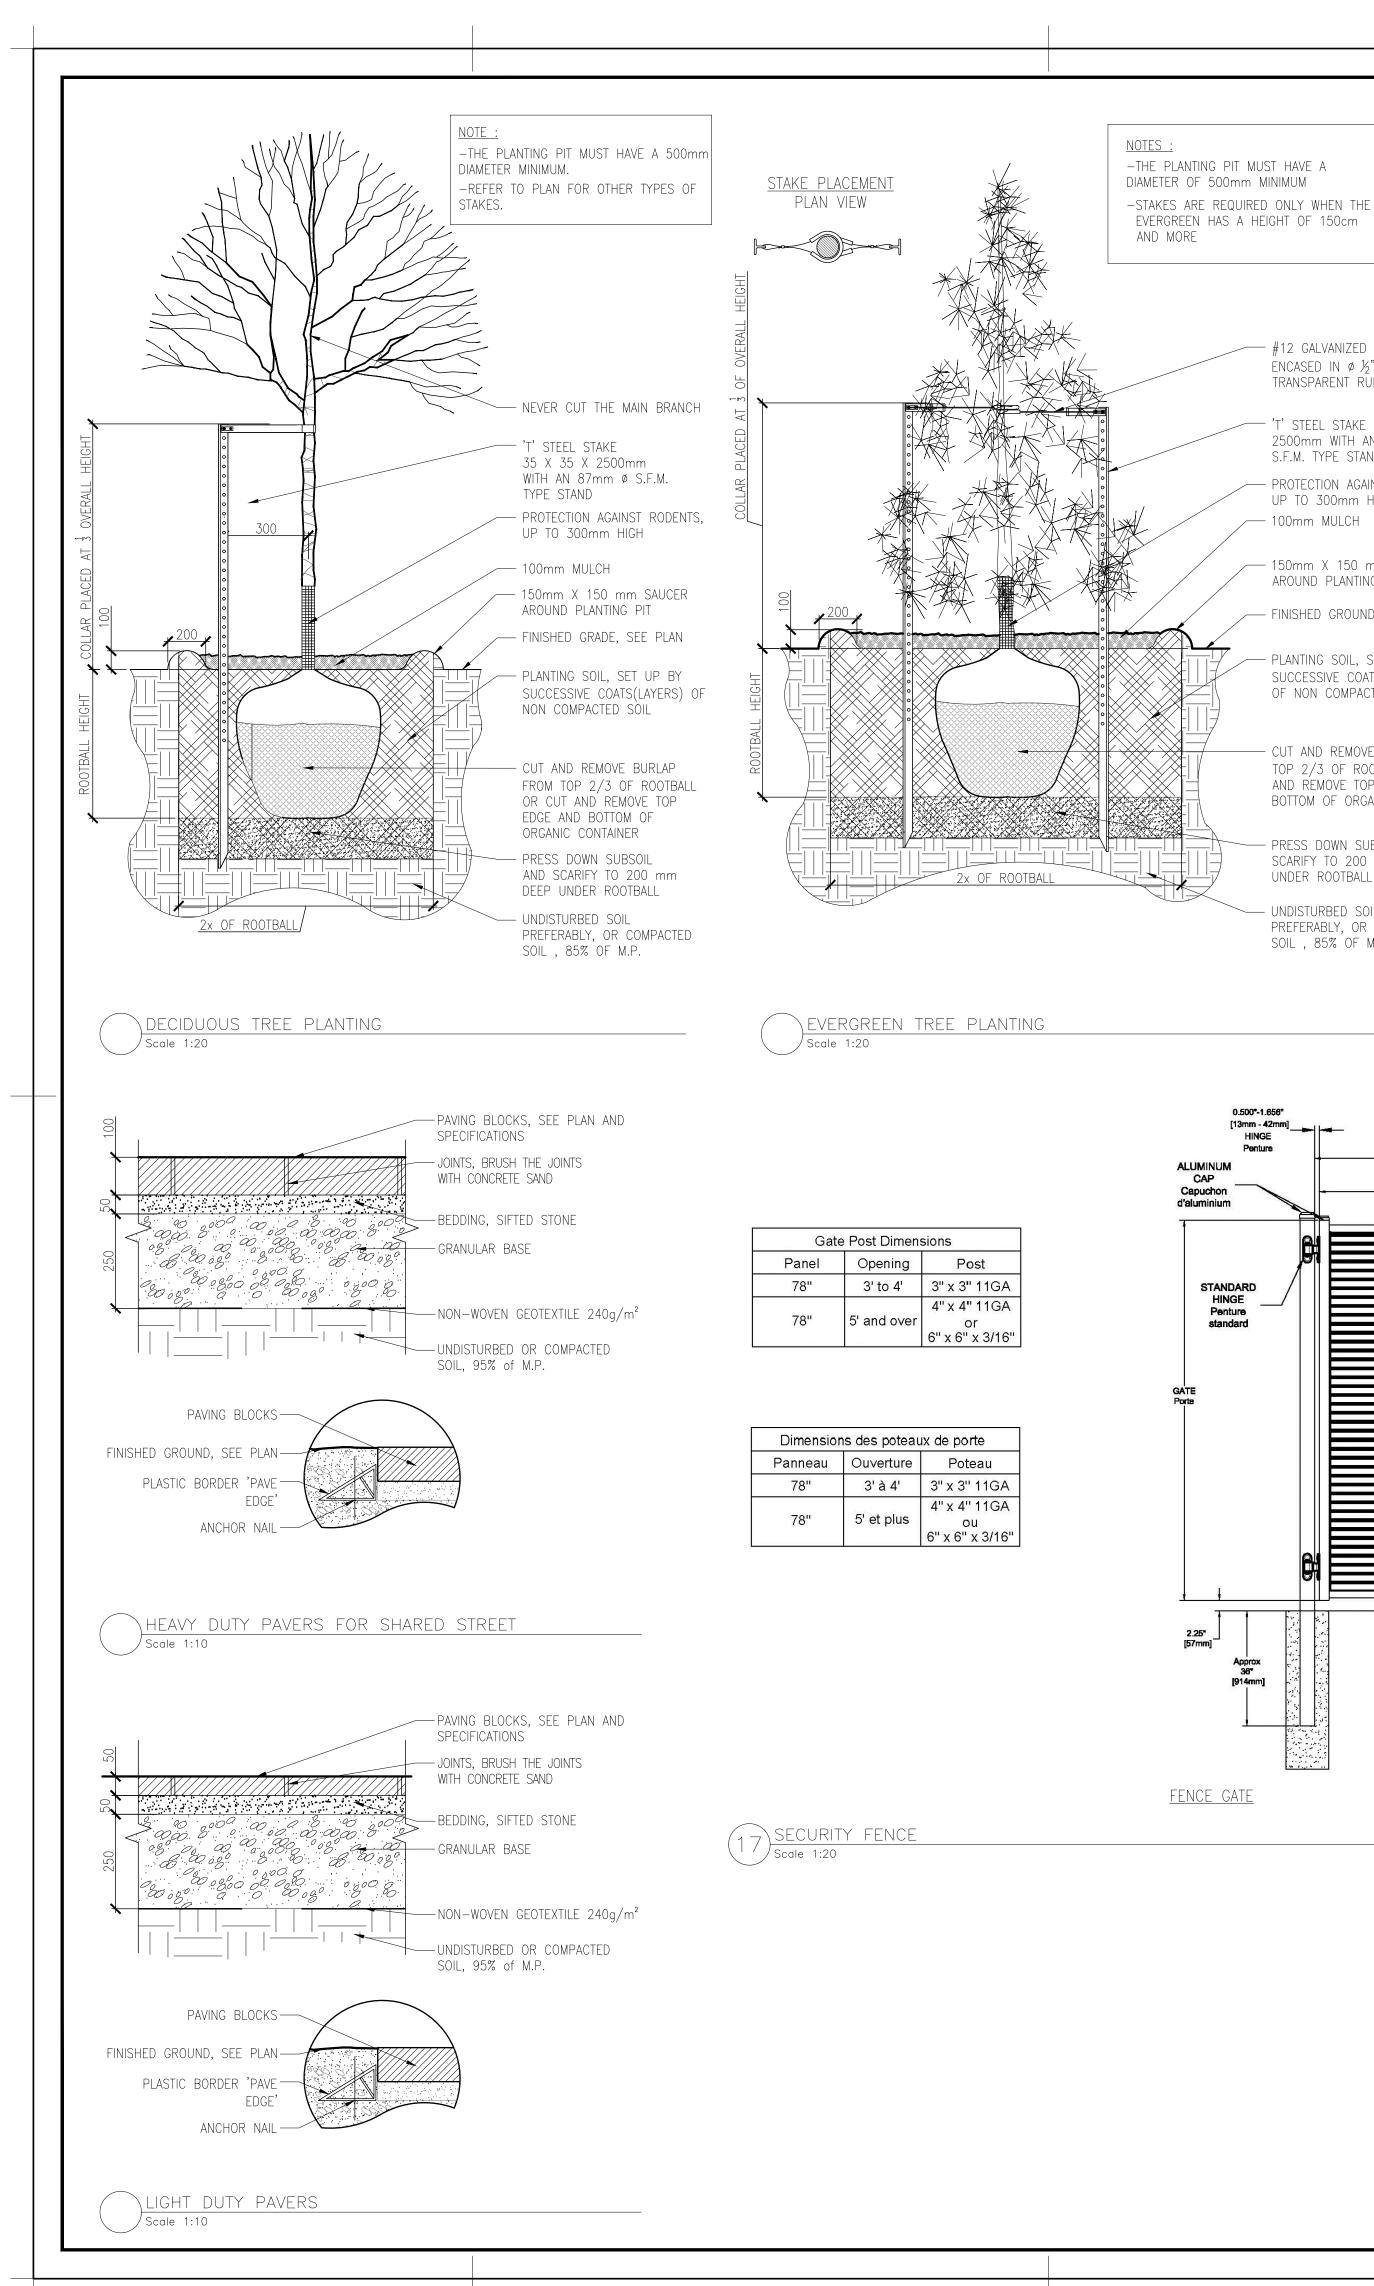

## DISTANCE OF PLANTATION

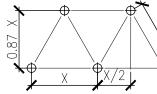


– 25mm MULCH DEPTH AT BASE OF SHRUB


— FINISHED GRADE, SEE PLAN

– PLANTING SOIL, SET UP BY SUCCESSIVE COATS(LAYERS) OF NON COMPACTED SOIL - REMOVE CONTAINER OR REMOVE THE TOP AND BOTTOM OF ORGANIC CONTAINER

- PRESS DOWN SUBSOIL AND SCARIFY TO 150 mm DEEP UNDER ROOTBALL

UNDISTURBED SOIL PREFERABLY, OR COMPACTED SOIL , 85% OF M.P.

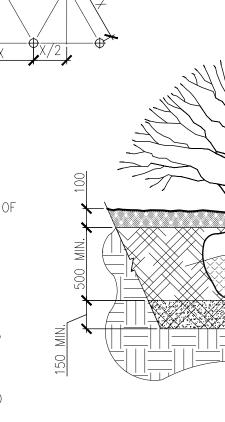

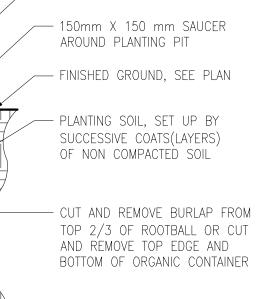

#12 GALVANIZED WIRE

TRANSPARENT RUBBER HOSE.

'T' STEEL STAKE 35 X 35 X

- PROTECTION AGAINST RODENTS,

2500mm WITH AN 87mm Ø

encased in ø ½"


S.F.M. TYPE STAND

UP TO 300mm HIGH

— 100mm MULCH

PRESS DOWN SUBSOIL AND SCARIFY TO 200 mm DEEP UNDER ROOTBALL

UNDISTURBED SOIL PREFERABLY, OR COMPACTED SOIL , 85% OF M.P.

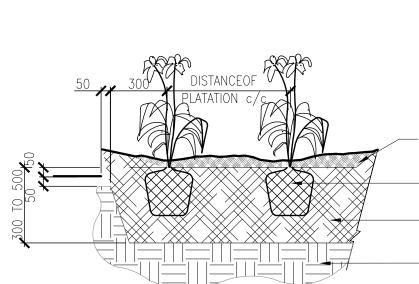

~ X X

2x ROOTBALL

∖shrub planting


PERENNIAL PLATATION

/ Scale 1:20

/Scale 1:20

- 100mm MULCH DEPTH AND 25mm AROUND BASE OF PERENNIALS - REMOVE PLASTIC CONTAINERS AND LOOSEN ROOTS AND SPREAD - THE PLANTING SOIL AROUND THE PLANTS, DO NOT COMPACT

- SCARIFY BOTTOM OF PLANTING PIT TO 150mm DEEP

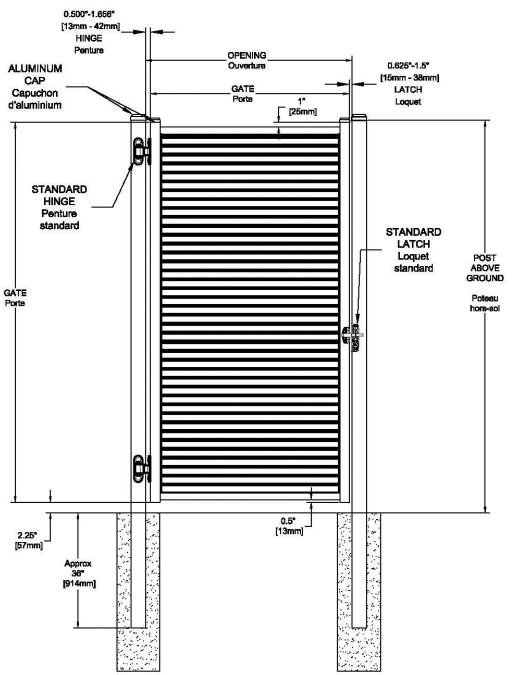

PANEL / Panneau 78" - HARDWARE KIT / 64 <del>5</del>" Kit de quincaillerie (1642mm) HOF Pers VEF Plat VEF Fils 77 <u>3</u>" (1975mm) <u>1</u>..\_\_\_\_ (6mm) NUMBER OF BRACKET KITS PER PANEL HEIGHT / POST / Nombre d'ensembles Hauteur du panneau d'attaches par poteau 1975 mm (77"H) 3 <u>FENCE</u>

<u>FENCE GATE</u>

| Ģ Ģ  | <u>NOTES :</u><br>—THE PLANTING PIT MUST HAVE A<br>DIAMETER OF 500mm MINIMUM   | Client   |
|--|--|--|
| × × × × × × × × × × × × × × × × × × ×  | 25mm MULCH DEPTH<br>AT BASE OF SHRUB<br>WATERING SAUCER<br>FINISHED GRADE SEE PLAN   | Revision         No       Description         1       SITE PLAN CONTROL         2       SITE PLAN CONTROL  |
|  | REMOVE CONTAINER OR<br>REMOVE THE TOP AND<br>BOTTOM OF ORGANIC<br>CONTAINER<br>PLANTING SOIL, SET UP BY<br>SUCCESSIVE COATS(LAYERS)<br>NON COMPACTED SOIL<br>PRESS DOWN SUBSOIL AND<br>SCARIFY TO 150 mm DEEP<br>UNDER ROOTBALL<br>UNDISTURBED OR COMPACTED<br>SOIL, 95% of M.P. |  |
|  |  | <ol> <li>Note :</li> <li>1. It is the responsion official to report discrepancies of conditions to the proceeding with</li> <li>2. The Contractor in vegetation without Director.</li> <li>3. Implantation of the by the Project Director in the contractor in the project Director in the project Director in the project Director in the contractor in the project Director in the contractor in the c</li></ol>       |
| NOTE:<br>– THE PERENNIALS ARE ALWAYS PLANTED IN STAGGE<br>LISTS OF PLANTATIONS AND PLANS)<br>– SPRAY THE GROUND WITH WATER IMMEDIATELY AFT |  | of all work. The conspecified in the second architect of any experiment of the close second for the contractor is authorities prior locations of under for the contractor is damaged as a result of the |
| RIZONTAL LOUVERS 0.08" THICK<br>rsiennes Horizontales 2mm  |  | <ul> <li>and by-laws.</li> <li>9. The contractor is run-off througho</li> <li>10. The Landscape subsurface cond</li> <li>11. The contractor is all plant materia Architect prior to</li> <li>9. All trees within 1 are to be excava</li> <li>10. Remove all prote after installation</li> <li>11. Staking of trees necessary.</li> <li>12. Ensure that mule 75mm from base</li> </ul>  |
| RTICAL FLAT2" x 11GAt Vertical50mm x 3mmRTICAL WIRES8GAverticalesØ4.06mm   |  |  |
| $5\frac{3}{16}$  |  | (A) MANAGER,<br>PLANNING, IN<br>DEVEVELOPMEN<br>PROJE<br>24 Mont-Royal Ouest, SI<br>Montréal, QC, H2T 2S2<br>514 849 7700  |
|  |  | Project name<br>333 MC<br>Ott  |
|  |  | Drawing title<br>CONSTRUCTION  |
|  |  | Drawn by:<br>B.DALLAS<br>Designed by :<br>B.DALLAS / S.GAL<br>Date :<br>MAY 2017<br>16-427   |



| Revision |                   |       |            |
|----------|-------------------|-------|------------|
| No       | Description       | Appr. | Date       |
| 1        | SITE PLAN CONTROL | E.P.  | 06/06/2017 |
| 2        | SITE PLAN CONTROL | S.G.  | 26/09/2017 |
|          |                   |       |            |
|          |                   |       |            |
|          |                   |       |            |
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|          |                   |       |            |

- sibility of the appropriate contractor port any errors, omissions or on this plan with actual site e Landscape Architect before
- h construction. must not cut down any existing out the approval of the Project
- the works on site must be approved irector.
- must use the Cad file for implantation contractor must verify the amounts schedule and notify the landscape errors, omissions or contradictions e of the bid.
- indicated on the plan come from the d by the owner.
- is to notify all utility companies and r to any excavation and ascertain derground services.
- is to reinstate all areas and items result of construction activity. is to comply with all pertinent codes
- is to maintain a positive surface out the entire construction period. e Architect is not responsible for
- ditions. is to stake the proposed location of
- al in conjunction with the Landscape o excavation.
- 1m of underground utility trenches vated by hand. tective wrapping from tree trunks
- s shall only be performed if
- llch is pulled back a min. distance of
- se of tree trunk.

|   | REFUSED  |                |
|---|--|----------------|
| THIS DAY OF _   | , 20   |                |
| DOUGLAS JAM<br>(A) MANAGER, DEVELO<br>PLANNING, INFRASTRI<br>DEVEVELOPMENT DEPAR<br><b>PROJJET</b><br>24 Mont-Royal Ouest, Suite 801<br>Montréal, QC, H2T 2S2<br>514 849 7700 | PMENT REVIEW C<br>UCTURE & ECONO<br>TMENT, CITY OF C | DMIC<br>DTTAWA |
| <sup>Project name</sup><br>333 MONTF<br>Ottawa,   |  | \D             |
| Drawing title   |  |                |
| CONSTRUCTION DETAIL   | LS   |                |
|   | SCALE  | E: AS SHOWN    |
| Drawn by:<br>B.DALLAS   | Sheet No.  |                |
|   |  |                |
| B.DALLAS / S.GALLANT<br>Date :  | LA-5   | 50             |
| MAY 2017  |  |                |
| 16-427  |  |                |